

# COUNTY OF MENDOCINO DEPARTMENT OF PLANNING AND BUILDING SERVICES

860 NORTH BUSH STREET · UKIAH · CALIFORNIA · 95482 120 WEST FIR STREET · FT. BRAGG · CALIFORNIA · 95437 BRENT SCHULTZ, DIRECTOR TELEPHONE: 707-234-6650 FAX: 707-463-5709 FB PHONE: 707-964-5379 FB FAX: 707-961-2427 pbs@mendocinocounty.org www.mendocinocounty.org/pbs

December 2, 2019

Department of Transportation Building Inspection - Ukiah Assessor Air Quality Management Office of Emergency Services CalFire - Prevention Cloverdale Rancheria Redwood Valley Rancheria Sherwood Valley Band of Pomo Indians

**CASE#:** UR\_2019-0003 **DATE FILED:** 6/25/2019

OWNER: BRIAN H & DONNA J WILSEY APPLICANT: T-MOBILE C/O SMARTLINK LLC

**AGENT:** LAUREN OTERI, TOWER ENGINEERING PROFESSIONALS

**REQUEST:** Renewal of previously Modified Use Permit UM\_2016-0002 to administratively change the expiration date to July 16, 2029. There are no proposed changes to the existing 70 ft. tall self supporting lattice tower, no associated ground equipment or requests for any physical modifications to the Wireless Communications Facility (WCF).

**LOCATION:** 2.5± miles southwest of the City of Ukiah center, on the north side of Oak Knoll Road (CR 252), 1.8± miles west of its intersection with Spanish Canyon Road (CR 252G), located at 1600 Oak Knoll Rd. Ukiah (APN: 157-160-10).

**ENVIRONMENTAL DETERMINATION:** Categorically Exempt

**SUPERVISORIAL DISTRICT: 5** 

**STAFF PLANNER:** CHEVON HOLMES **RESPONSE DUE DATE:** December 16, 2019

#### PROJECT INFORMATION CAN BE FOUND AT:

https://www.mendocinocounty.org/government/planning-building-services/public-agency-referrals

Mendocino County Planning & Building Services is soliciting your input, which will be used in staff analysis and forwarded to the appropriate public hearing. You are invited to comment on any aspect of the proposed project(s). Please convey any requirements or conditions your agency requires for project compliance to the project coordinator at the above address, or submit your comments by email to <a href="mailto:pbs@mendocinocounty.org">pbs@mendocinocounty.org</a>. Please note the case number and name of the project coordinator with all correspondence to this department.

We have reviewed the above a	pplication and recommend the following	ng (please check one):
☐ No comment at this time.		
☐ Recommend conditional app	proval (attached).	
	al information (attach items needed, o ces in any correspondence you may h	r contact the applicant directly, copying ave with the applicant)
Recommend denial (Attach	reasons for recommending denial).	
☐ Recommend preparation of	an Environmental Impact Report (atta	ch reasons why an EIR should be required).
Other comments (attach as	necessary).	
REVIEWED BY:		
Signature	Department	Date

**CASE:** UR 2019-0003

OWNER: Brian & Donna J Wilsey

**APPLICANT:** T-Mobile c/o Smartlink LLC

**AGENT:** Lauren Oteri c/o Tower Engineering Professionals

REQUEST: Renewal of previously Modified Use Permit UM\_2016-0002 to administratively change the expiration date to July

16, 2029. There are no proposed changes to the existing 70 ft. tall self-supporting lattice tower, no associated ground equipment or requests for any physical modifications to the Wireless Communications Facility (WCF).

LOCATION: 2.5± miles southwest of the City of Ukiah center, on the north side of Oak Knoll Road (CR 252), 1.8± miles west of

its intersection with Spanish Canyon Road (CR 252G), located at 1600 Oak Knoll Rd. Ukiah (APN: 157-160-10).

**APN/S:** 157-160-10-00

PARCEL SIZE: 5,625 ft<sup>2</sup> leased of 34.64 ± Acre Parcel

GENERAL PLAN: Remote Residential 20 Acre Minimum (RMR20)

**ZONING:** Upland Residential 40 Acre Minimum (UR:40)

**EXISTING USES:** Residential and Telecommunications

**SUPERVISORIAL DISTRICT:** 5<sup>TH</sup> (Williams)

**RELATED CASES:** • Minor Subdivision MS# 204-77 created 4 parcels including the subject parcel. Subsequent Boundary Line Adjustment B# 67-87 was approved resulting in the parcel's current configuration. General Plan Amendment GP# 21-87 (approved by Board of Supervisors July 22,1988) successfully changed the General Plan land use classification from Remote Residential – 40 acre minimum to Remote Residential – 20 acre minimum, however a Rezone application was never received and therefore, the Upland Residential – 40 acre minimum base zoning designation remains today.

- On January 4, 2001, the Planning Commission approved U# 22-2000 and granted conditional approval for US Cellular to construct a 150-foot tall telecommunication tower on the Wilsey property. The Commission's decision was not appealed to the Board of Supervisors. After the tower was constructed, numerous residents began to express concerns regarding aesthetic impacts, devalue of property and damage to Oak Knoll Road. Formal complaints were filed with the Department of Planning and Building Services claiming that the applicant supplied misleading written and verbal information at the public hearing which influenced the Commission to approve the project. Additional allegations from the public included constructing the tower in a different location than shown on the site plan and that the tower may be taller than the 150 foot approved height.
- The Commission met on May 2, 2002 to determine the validity of public concerns and possibly take action to modify condition terms or revoke the Use Permit entirely (Use Permit Modification/Revocation UM# 22-2000/2002). After much discussion, the Commission chose to add new and modify previous conditions reducing the overall tower height to less than 75 feet, limiting total panel and microwave antennas on tower by all wireless carriers to twelve or less, and restricting the use of a generator or propane tank at the site unless authorized by a future use permit modification.
- On July 16, 2009, the Planning Commission approved Use Permit Modification #UM 22-2000/2009 to add three (3) panel antennas and one (1) microwave dish to the existing 65 foot tall telecommunication tower and to place a battery backup power system, a GPS antenna and four (4) equipment cabinets within a 5,625 square foot leased area.
- December 31, 2014 the Zoning Administrator approved Administrative Permit AP\_2014-0025 to add one (1) Long-Term Evolution (LTE) antenna, one (1) pipe mount and two (2) coax.
- On October 4, 2016 the Planning Commission approved Use Permit Modification UM\_2016-0002 to add a backup generator, propane fuel tank and concrete pad to the existing telecommunications facility.
- On September 16, 2019 Administrative Permit AP\_2019-0046 was approved to install three (3) new antennas and three (3) new radio units on the existing 70 foot tall lattice telecommunications tower.

	ADJACENT GENERAL PLAN	ADJACENT ZONING	ADJACENT LOT SIZES	ADJACENT USES
NORTH:	Remote Residential 40 Acres Mi	Upland Residential 40 Acres Mi	81.86 +/- Acres	Vacant
EAST:	Remote Residential 40 Acres Mi	Upland Residential 40 Acres Mi	20 +/- Acres & 40 +/- Acres	Residential
SOUTH:	Rangeland 160 Acre Minimum (RL	Rangeland 160 Acre Minimum (RL	17.47 +/- Acres & 23.61 Acres	Residential
WEST:	Rangeland 160 Acre Minimum (RL	Rangeland 160 Acre Minimum (RL	5.48 +/- Acres	Telecom Facility

LOCAL

☑ Air Quality Management District☑ Assessor's Office☑ Building Division Ukiah

☑ Department of Transportation (DOT)
 ☑ Office of Emergency Services
 <u>STATE</u>
 ☑ CALFIRE (Land Use)

**TRIBAL** 

☑ Cloverdale Rancheria☑ Redwood Valley Rancheria☑ Sherwood Valley Band of Pomo Indians

**ADDITIONAL INFORMATION:** The purpose of the request is to renew Use Permit # UM22-2000/2009 to extend the expiration date to July 16, 2029. According to the application "the sole purpose of this application is to renew the existing Use Permit" and no modifications to the existing tower and compound are proposed.

STAFF PLANNER: CHEVON HOLMES DATE: 12/2/2019

#### **ENVIRONMENTAL DATA**

**1. MAC**:

N/A

2. FIRE HAZARD SEVERITY ZONE:

CALEIDE EDAD mans/GIS

High and Very High Fire Hazard

3. FIRE RESPONSIBILITY AREA:

CALFIRE FRAP maps/GI

Ukiah Valley Fire Protection District

4. FARMLAND CLASSIFICATION:

GIS

5. FLOOD ZONE CLASSIFICATION:

FEMA Flood Insurance Rate Maps (FIRM)

NO

6. COASTAL GROUNDWATER RESOURCE AREA:

Coastal Groundwater Study/GIS

N/A

7. SOIL CLASSIFICATION:

Mendocino County Soils Study Eastern/Western Part

Maymen-Estel-Snook

8. PYGMY VEGETATION OR PYGMY CAPABLE SOIL:

LCP maps, Pygmy Soils Maps; GIS

N/A

9. WILLIAMSON ACT CONTRACT:

GIS/Mendocino County Assessor's Office

NO

**10. TIMBER PRODUCTION ZONE:** 

GIS

NO

11. WETLANDS CLASSIFICATION:

NO

12. EARTHQUAKE FAULT ZONE:

Earthquake Fault Zone Maps; GIS

NO

13. AIRPORT LAND USE PLANNING AREA:

Airport Land Use Plan; GI

NΩ

14. SUPERFUND/BROWNFIELD/HAZMAT SITE:

GIS; General Plan 3-11

NO

15. NATURAL DIVERSITY DATABASE:

CA Dept. of Fish & Wildlife Rarefind Database/GIS

NO

16. STATE FOREST/PARK/RECREATION AREA ADJACENT:

GIS; General Plan 3-10

NO

**17. LANDSLIDE HAZARD:** 

Hazards and Landslides Map; GIS; Policy RM-61; General Plan 4-44

NO

18. WATER EFFICIENT LANDSCAPE REQUIRED:

Policy RM-7; General Plan 4-34

NO

19. WILD AND SCENIC RIVER:

www.rivers.gov (Eel Only); GIS

N/A

20. SPECIFIC PLAN/SPECIAL PLAN AREA:

Various Adopted Specific Plan Areas; GIS

NO

21. STATE CLEARINGHOUSE REQUIRED:

NO

NO

22. OAK WOODLAND AREA:

USDA A / A

N/A

23. HARBOR DISTRICT:

Sec. 20.512

NO



# Planning and Building Services

1 0 0 0
Case No: <u>UE 2014-003</u>
CalFire No:
Date Filed: 5-19
Fee: Vaha 0
Fee: Patral Receipt No:
Receipt No.
Received By:
Received By.
Office use only
Office use offly

### **APPLICATION FORM**

APPLICANT Name: T-Mobile/ c/o Sm	artlink LLC	Phone:		
Mailing Address: 621 SW Alder Stree	et Suite 660			
City: Portland	State/Zip: OR/9707	0 email:		
PROPERTY OWNER Name:Brian all	nd Donna Wilsey	Phone:		
Mailing Address <u>:</u> 13750 Mountain Horse R	oad			
City: Hopland	State/Zip: CA/ 954	49 email:		
AGENT Name: Tower Engineering P	rofessionals (Lauren O	teri) Phone:	980-202-6514	
Mailing Address: 10700 Sikes Place Suite	360			
City: Charlotte	State/Zip: NC/ 2827	7 email:	loteri@tepgroup.ne	et
Parcel Size: 5,625sq ft/ 40 acr	es (Sq. feet/Acres) Addres	ss of Property <u>: 1600 Oak</u>	K Knoll Road, Ukiah, CA	
Assessor Parcel Number(s):	157-160-10			
TYPE OF APPLICATION:				
☐ Administrative Permit ☐ Agricultural Preserve ☐ Airport Land Use ☐ CDP- Admin ☐ CDP- Standard ☐ Certificate of Compliance ☐ Development Review ☐ Exception	☐ Land Divisi ☐ Land Divisi ☐ Land Divisi ☐ Land Divisi	an Amendment on-Minor on- Major on-Parcel on-Resubdivision n of Conditions	☐ Rezoning☐ Use Permit☐ Use Permit☐ Use Permit☐ Variance☐ Other	-Minor
I certify that the information sub	omitted with this applica	rtion is true and accura	ate.	
Lauren Oteri Signature of Applicant/Agent	7/2/2019 Date	Signature of	Owner	7/2/2019 Date
		ESSENTIAL SECTION	CEIVE	

Z:\1.PBS Forms\COMPLETED Form\Planning Application-2015.docx Page - 1



#### SITE AND PROJECT DESCRIPTION QUESTIONNAIRE

The purpose of this questionnaire is to relate information concerning your application to the Department of Planning and Building Services and other agencies who will be reviewing your project proposal. Please remember that the clearer picture that you give us of your project and the site, the easier it will be to promptly process your application. Please answer all questions. Those questions which do not pertain to your project please indicate "Not applicable" or "N/A".

#### THE PROJECT

	Describe your project. Incluvegetation removal, roads, et		ovements such a	s wells, septic	systems, gradir	າg, ——
	US Cellular is RENEW	ING the existin	na Use Permit	# U22-200	 O There will	— he
	no changes being done					
	existing Use Permit.	- 1110 0010 p. c.		/piiodiio	TOHOTE GIS	—
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		Number	of Units		Square Footage	
	ructures/Lot Coverage	Number Existing	of Units Proposed	Existing	Square Footage	
Si   M   Do	ngle Family obile Home uplex lultifamily				<del></del>	
Si M Di Di	ngle Family obile Home uplex lultifamily ther: Cell Tower				<del></del>	
Si M	ngle Family obile Home uplex lultifamily				<del></del>	

3.	If the project is commercial, industrial or institutional, complete the following:
	Estimated employees per shift: N/A  Estimated shifts per day: N/A  Type of loading facilities proposed: N/A
ļ _ <u></u>	Type of loading facilities proposed: N/A
4.	Will the proposed project be phased?   Yes  No If yes, explain your plans for phasing:
5.	Will vegetation be removed on areas other than the building sites and roads? ☐Yes ■No Explain:
6.	Will the project involve the use or disposal of potentially hazardous materials such as toxic substances, flammables, or explosives? ☐Yes ■No If yes, explain:
7.	How much off-street parking will be provided?  Number Size
	Number of covered spaces  Number of uncovered spaces  Number of standard spaces  Number of handicapped spaces
	Existing Number of Spaces Proposed Additional Spaces Total
8.	Is any road construction or grading planned?   Yes No If yes, grading and drainage plans may be required. Also, describe the terrain to be traversed (e.g., steep, moderate slope, flat, etc.).
9.	For grading or road construction, complete the following:
	A. Amount of cut cubic yards B. Amount of fill cubic yards C. Maximum height of fill slope feet D. Maximum height of cut slope feet
	E. Amount of import or export cubic yards F. Location of borrow or disposal site

10.	Does the project involve sand removal, mining or gravel extraction?  If yes, detailed extraction, reclamation and monitoring plans may be required?
11.	Will the proposed development convert land currently or previously used for agriculture to another use? ☐Yes ■No
	If yes, how many acres will be converted?acres. An agricultural economic feasibility study may be required.
12.	Will the development provide public or private recreational opportunities? ☐Yes ☐No If yes, explain below: N/A
13.	Is the proposed development visible from State Highway 1 or other scenic route?  ☐Yes ■No  14. Is the proposed development visible from a park, beach or other recreational area?  ☐Yes ■No
15.	Does the development involve diking, filling, dredging or placing structures in open coastal water, wetlands, estuaries or lakes?
	Diking: ☐Yes ☐No Placement of structures in: Filling: ☐Yes ☐No ☐open coastal waters Dredging: ☐Yes ☐No ☐wetlands ☐estuaries ☐lakes
	If so, amount of material to be dredged or filled?cubic yards.
	Location of dredged material disposal site?  Has a U.S. Army Corps of Engineers permit been applied for?
16.	Will there be any exterior lighting?   Yes No If yes, describe below and identify the location of all exterior lighting on the plot plan and building plans.  N/A
17,	Utilities will be supplied to the site as follows:  A. Electricity:  Utility Company (service exists to the parcel)  Utility Company (requires extension of service to site:feetmiles)  On Site Generation - Specify: N/A  B. Gas:
	Utility Company/Tank ☐ On Site Generation - Specify: N/A ☐ None  C. Telephone: ☐ Yes ■ No
18.	What will be the method of sewage disposal?  ☐Community sewage system - Specify supplier ☐Septic Tank ☐Other - Specify: N/A
19.	What will be the domestic water source:  Community water system - Specify supplier  Well Spring Other - Specify: N/A

20.	Are there any asso ☐Yes	ociated projects ■No		oroperties under your o e.g., Assessor's Parce	ownership? el Number, address, etc	);
21.				er public approval requind federal agencies:	uired for this project, ind	cluding those required
22.	Describe the location intersections, etc.):		n terms of readily i	identifiable landmarks	(e.g., mailboxes, mile p	posts, street
23.	Are there existing s If yes, describe bel- subdivision.			☐Yes ■No structure on the plot p	olan or tentative map if t	the proposal is for a
24.	Will any existing st				o cluding the relocation si	ite, if applicable.
25.	Project Height. Ma	ximum height c	of existing structure	es <u>70</u> feet. Maximu	m height of proposed st	tructures 70 feet.
26.	Gross floor area of area of proposed s	existing structi tructures_75	ures <u>75</u> square fe square feet (includ	et (including covered ding covered parking a	parking and accessory and accessory buildings)	buildings). Gross floor ).
27.	Lot area (within pro	perty lines):	square	feet □acres.		
28.		tability, plants a	and animals, and a		formation on existing str or scenic aspects. Atta	
						<del>`</del>
29.		he type of land			s, animals and any cultu ntensity. Attach any pho	ural, historic or scenic otographs of the vicinity
	N/A					
30.	Indicate the surr	rounding land u	uses: North	East	South	West
	Vacant		110.0.			
	Residential Agricultu Commercial Industria				,	<del></del>
	Institutional Timberla					
	Other					

#### CERTIFICATION AND SITE VIEW AUTHORIZATION- SUBMIT ONLY ONE COPY

I hereby certify that I have read this completed application and that, to the best of my knowledge, the information in this application, and all attached appendices and exhibits, is complete and correct. I understand that the failure to provide any requested information or any misstatements submitted in support of the application shall be grounds for either refusing to accept this application, for denying the permit, for suspending or revoking a permit issued on the basis of such misrepresentations, or for seeking of such further relief as may seem proper to the County.
 I hereby grant permission for County Planning and Building Services staff and hearing bodies to enter upon and site view the premises for which this application is made in order to obtain information necessary for the preparation of required reports and render its decision.

 Z/2/2019

Authorized Agent

NOTE: IF SIGNED BY AGENT, OWNER MUST SIGN BELOW.

AUTHORIZATION OF AGENT

I hereby authorize Tower Engineering Professionals to act as my representative and to bind me in all matters concerning this application.

7/8/2019

Owner

Date

#### MAIL DIRECTION

To facilitate proper handling of this application, please indicate the names and mailing addresses of individuals to whom you wish correspondence and/or staff reports mailed if different from those identified on Page 1 of the application form.

Name Lauren Oteri (agent)	Name	Name
Mailing Address 10700 SIKES PLACE SUITE 360 Charlotte NC 2827	Mailing Address	Mailing Address


#### INDEMNIFICATION AND HOLD HARMLESS

ORDINANCE NO. 3780, adopted by the Board of Supervisors on June 4, 1991, requires applicants for discretionary land use approvals, to sign the following Indemnification Agreement. Failure to sign this agreement will result in the application being considered incomplete and withheld from further processing.

#### INDEMNIFICATION AGREEMENT

As part of this application, applicant agrees to defend, indemnify, release and hold harmless the County of Mendocino, its agents, officers, attorneys, employees, boards and commissions, as more particularly set forth in Mendocino County Code Section 1.04.120, from any claim, action or proceeding brought against any of the foregoing individuals or entities, the purpose of which is to attack, set aside, void or annul the approval of this application or adoption of the environmental document which accompanies it. The indemnification shall include, but not be limited to, damages, costs, expenses, attorney fees or expert witness fees that may be asserted by any person or entity, including the applicant, arising out of or in connection with the approval of this application, whether or not there is concurrent, passive or active negligence on the part of the County, its agents, officers, attorneys, employees, boards and commissions.

Applicant:	Lauren Oteri	Date:	7/15/2019	

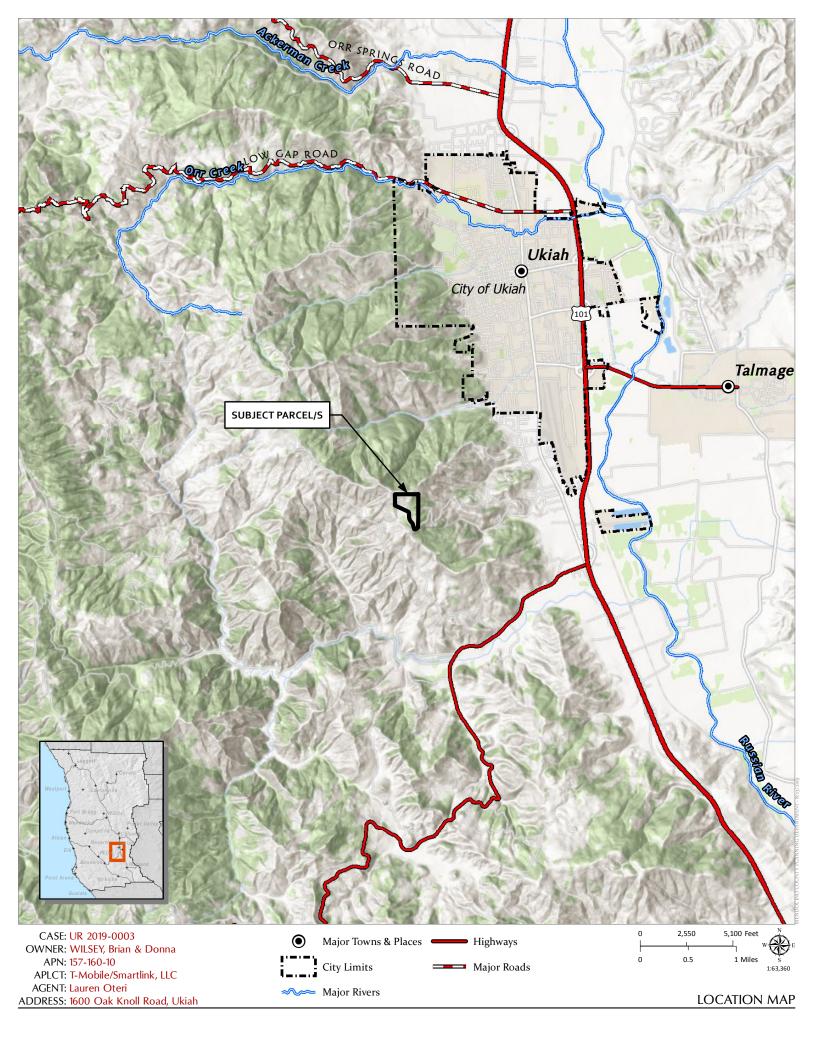





CASE: UR 2019-0003 OWNER: WILSEY, Brian & Donna APN: 157-160-10

APLCT: T-Mobile/Smartlink, LLC AGENT: Lauren Oteri ADDRESS: 1600 Oak Knoll Road, Ukiah



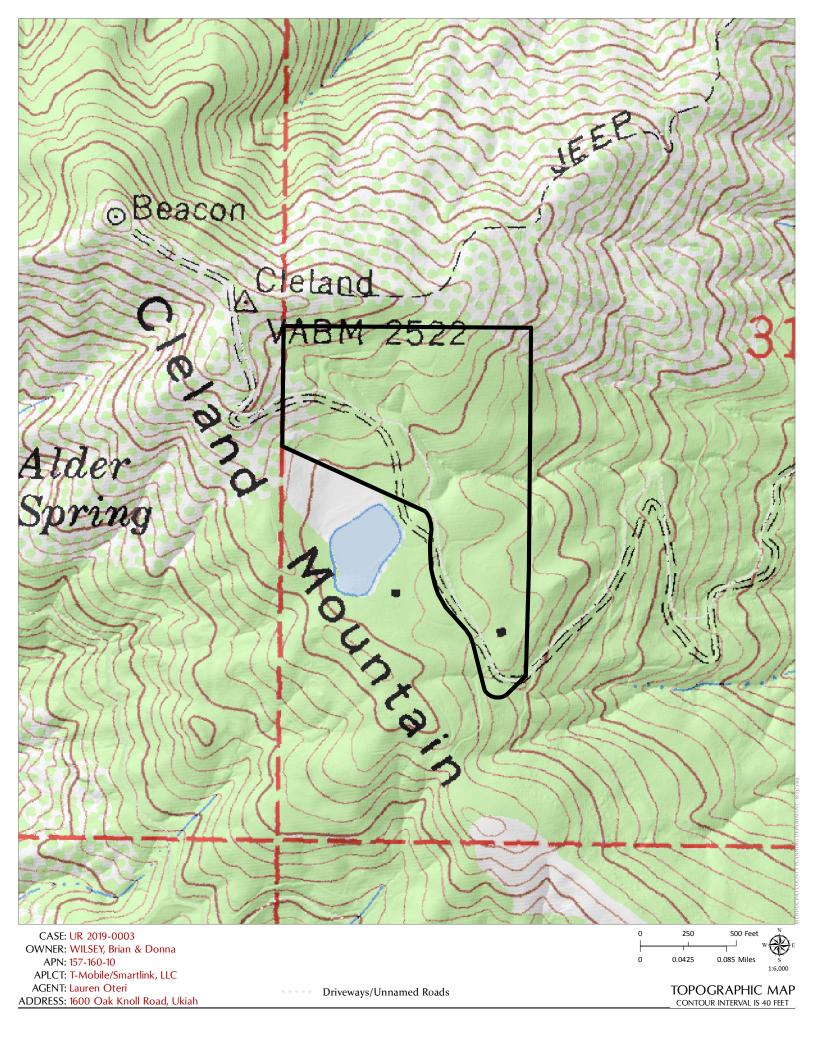

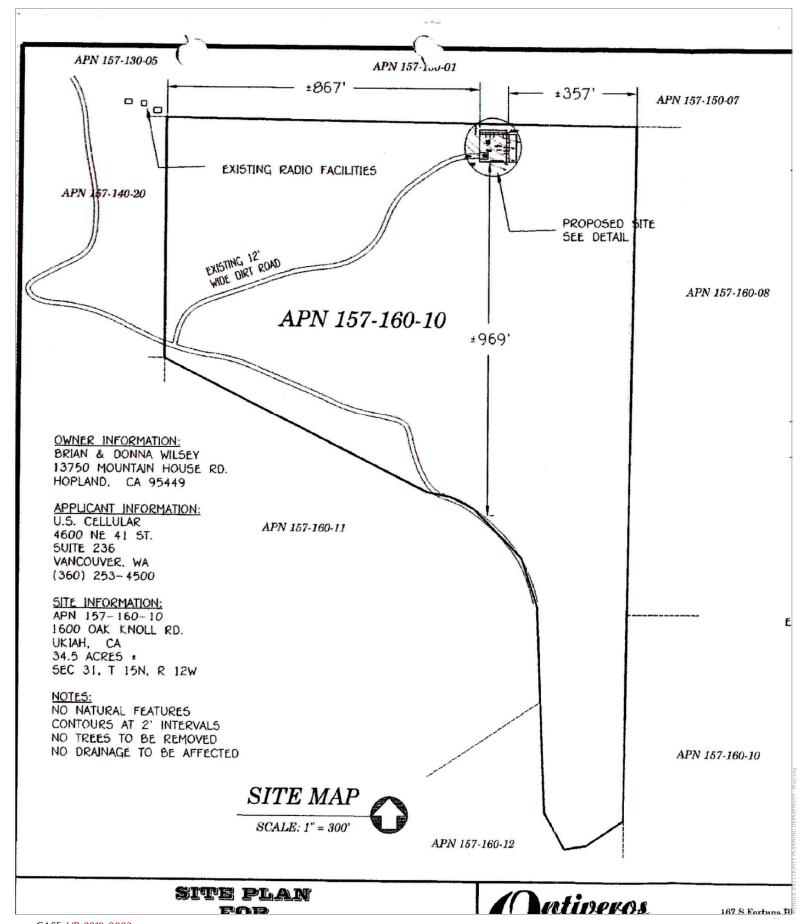



CASE: UR 2019-0003 OWNER: WILSEY, Brian & Donna APN: 157-160-10


APLCT: T-Mobile/Smartlink, LLC AGENT: Lauren Oteri


ADDRESS: 1600 Oak Knoll Road, Ukiah


NO SCALE

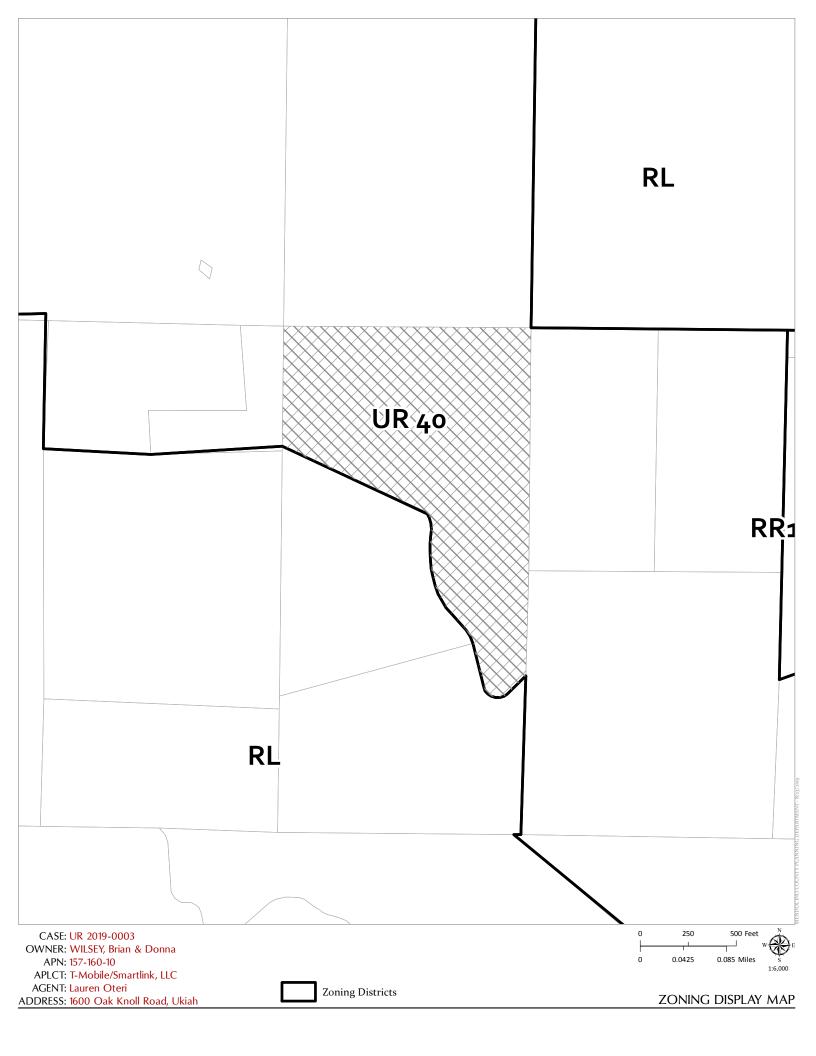

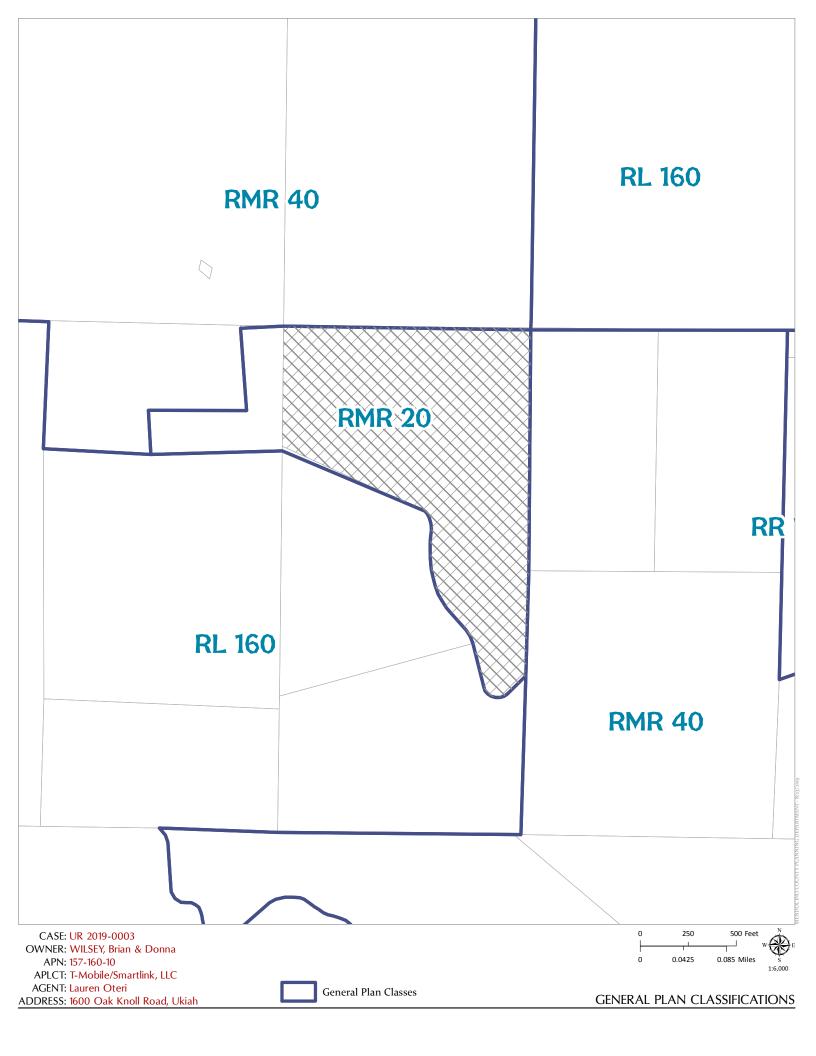

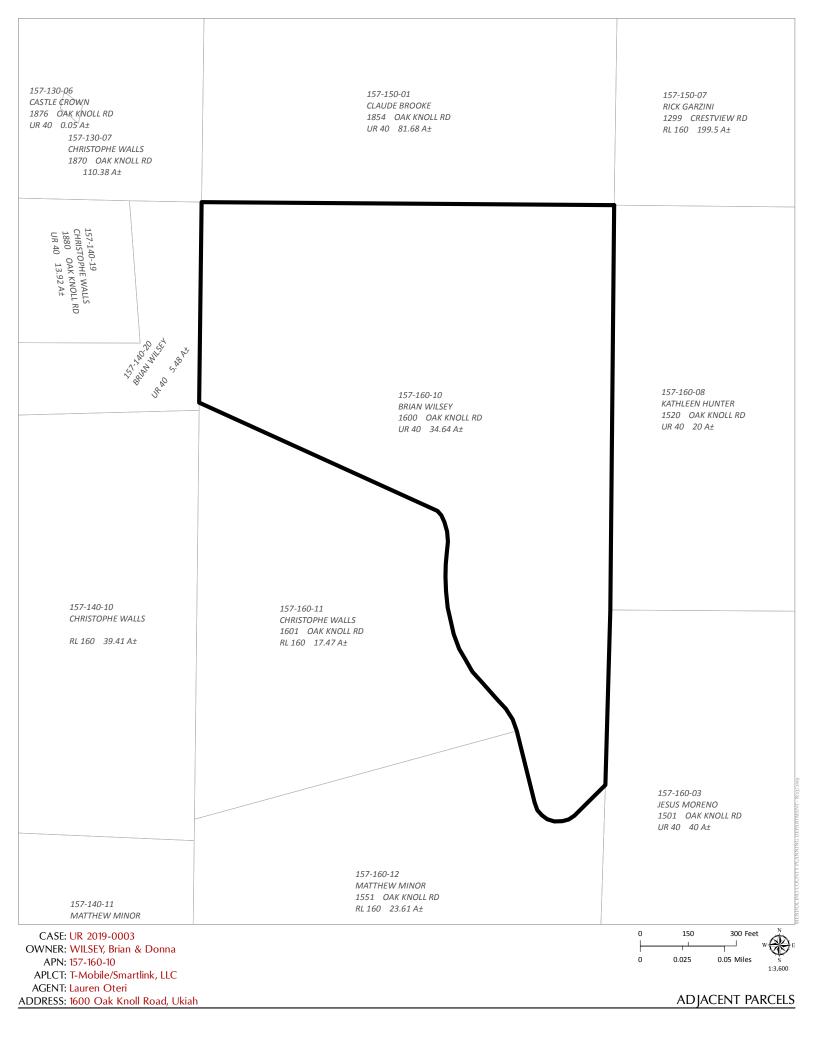

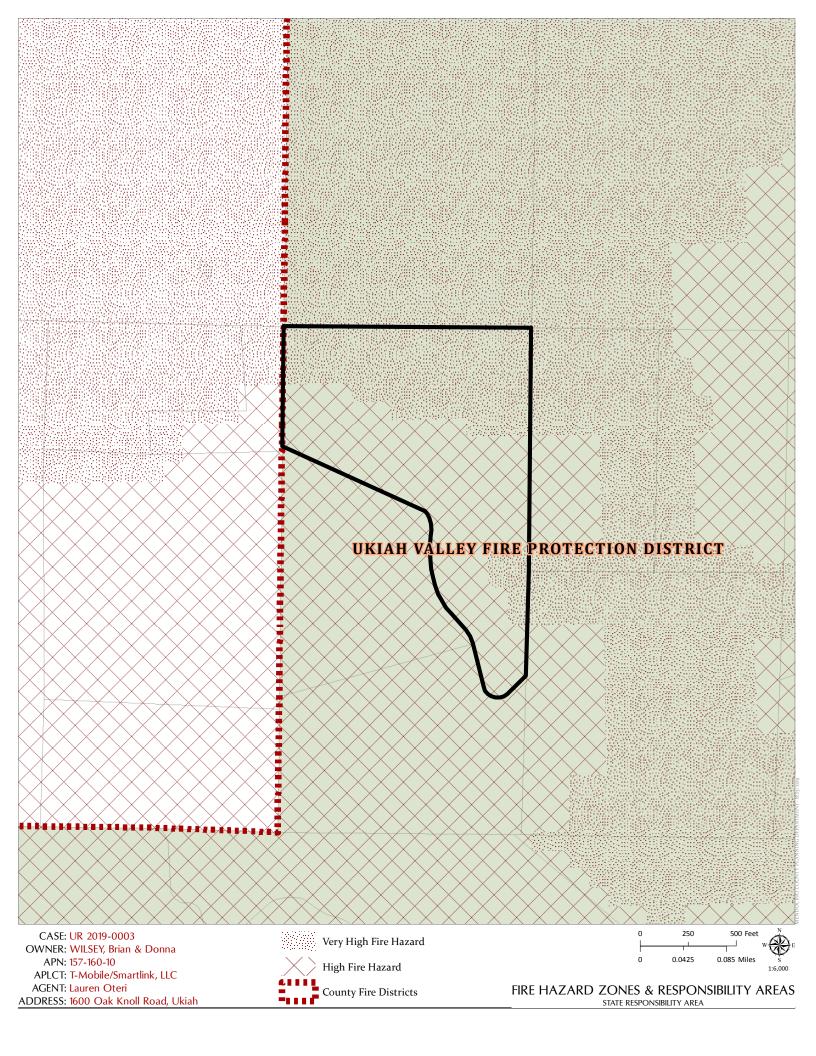


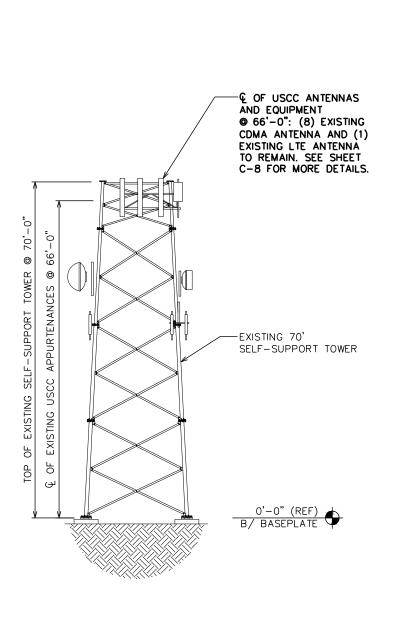





**EXISTING USCC LTE TAG** 

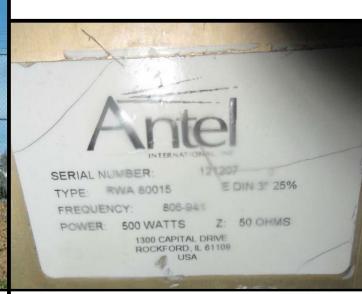

**EXISTING USCC CDMA TAG** 




8410 W. BRYN MAWR SUITE 700 CHICAGO, IL 60631 (773) 399-8900

PROJECT INFORMATION:

#### 568378 **SPANISH MT**


1600 OAK KNOLL ROAD UKIAH, CA 95482 (MENDOCINO COUNTY)

PLANS PREPARED BY:

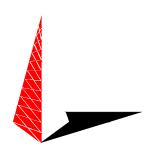

#### **TOWER ENGINEERING PROFESSIONALS**

326 TRYON ROAD RALEIGH, NC 27603-3530 OFFICE: (919) 661-6351 www.tepgroup.net

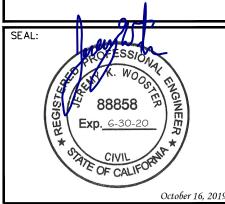

-	10-16-19	CONSTRUCTION
0	09-19-19	PRELIMINARY
REV	DATE	ISSUED FOR:

DRAWN BY: HH CHECKED BY:

SHEET TITLE:

**TOWER ELEVATION** 

SHEET NUMBER:

REVISION:

TEP#: 52509

**EXISTING TOWER ELEVATION** 20 SCALE: 1" = 20' SCALE IN FEET

**EXISTING TOWER ELEV.** 

#### STRUCTURAL NOTE

- STRUCTURAL STATUS:
  TOWER SA N/A
  MOUNT SA N/A

#### SCOPE OF WORK

#### TOWER SCOPE:

- EXISTING EQUIPMENT TO REMAIN:

  (3) ANTEL BXA BOO40/4 CDMA PANEL ANTENNAS
  (3) ANTEL RWB BOO15 CDMA PANEL ANTENNAS
  (2) ANTEL RWB BOO15 CDMA PANEL ANTENNAS
  (1) KMW AM-X-CW-18-65-DOT-RET LTE ANTENNA
  (6) PH % CDMA CDAX
  (7) PH % CDMA CDAX
  (8) PH % LTE COAX
  (9) PH % LTE COAX

TOP TOWER GROUND BAR: NO PROPOSED CHANGES

BOTTOM TOWER GROUND BAR: NO PROPOSED CHANGES

#### SHELTER EXTERIOR SCOPE:

ICE BRIDGE: NO PROPOSED CHANGES

SHELTER COAX PORT: NO PROPOSED CHANGES

SHELTER EXTERIOR GROUND BAR: NO PROPOSED CHANGES

SHELTER INTERIOR SCOPE:
EXISTING EQUIPMENT:
(2) EXISTING FXCB RRHs, (1) FRLB RRHs AND (2)
COMBINERS TO REMAIN IN SHELTER.

# STATE LOCATION

#### SITE LOCATION



#### **PROJECT TEAM**

#### PROJECT CONTACT:

U.S. CELLULAR CORPORATION 8410 W BRYN MAWR SUITE 700 **ADDRESS** CITY, STATE, ZIP CHICAGO, IL 60631 CONTACT

JOHN MAUDLIN PHONE (888) 944-9400

#### SITE ACQUISITION:

TOWER ENGINEERING PROFESSIONALS, INC. NAMF 10700 SIKES PLACE, SUITE 360 **ADDRESS** 

CITY, STATE, ZIP CHARLOTTE, NC 28277

CONTACT MARK HUDAK (980) 202-5553

#### **TOWER OWNER:**

NAME US CELLULAR CORPORATION **ADDRESS** 8410 W. BRYN MAWR, SUITE 700 CHICAGO, IL 60631 CITY, STATE, ZIP

CONTACT JOHN MAUDLIN (888) 944-9400

#### **CIVIL ENGINEER:**

NAME TOWER ENGINEERING PROFESSIONALS, INC. **ADDRESS** 326 TRYON ROAD

RALEIGH, NC 27603-3530 CITY, STATE, ZIP CONTACT JEREMY K. WOOSTER, P.E.

PHONE (919) 661-6351

# 97 LCAP Q318 DRAWINGS

# **SPANISH MT**

SITE NUMBER:

568378

SITE ADDRESS:

# **1600 OAK KNOLL ROAD UKIAH, CA 95482** (MENDOCINO COUNTY)

#### PROJECT INFORMATION

N 39° 06' 58.00" \* LATITUDE: W 123° 13' 46.98" \* LONGITUDE:

GROUND ELEVATION: 2,345'± (GOOGLE EARTH)\*\*

\* INFORMATION PROVIDED USCC \*\* INFORMATION FROM GOOGLE EARTH

**TOWER TYPE:** 70' SELF-SUPPORT TOWER

**LOADING TYPE:** 4T4R **ACCESS ISSUES:** N/A **GATE COMBO:** N/A



#### **INDEX OF SHEETS**

NO.	SHEET TITLE	REV
T-1	TITLE SHEET	1
C-1	SITE SURVEY	1
C-2	COMPOUND DETAIL	1
C-3	SHELTER DETAILS	1
C-4	TOWER ELEVATION	1
C-5	HATCH PLATE & ICE BRIDGE DETAILS	1
C-6	COAX LAYOUT	1
C-7	GROUND BAR DETAILS	1
C-8	ANTENNA MOUNTING DETAILS	1
N-1	GENERAL NOTES	1
-	-	_
-	-	-
1	-	_
-	-	-
_	-	_
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_	-	_
_	-	_

#### STRUCTURAL NOTE

STRUCTURAL STATUS:

- TOWER SA N/A
- MOUNT SA N/A

#### **SCOPE OF WORK**

#### **TOWER SCOPE:**

EXISTING EQUIPMENT TO REMAIN:
(3) ANTEL BXA 80040/4 CDMA PANEL ANTENNAS
(3) ANTEL RWB 80016/90 CDMA PANEL ANTENNAS
(2) ANTEL RWA 80015 CDMA PANEL ANTENNAS KMW AM-X-CW-18-65-00T-RET LTE ANTENNA

(6) FH 1/8" COAX (CUT IN SHELTER) (6) FH 1/8" CDMA COAX (2) FH 1/8" LTE COAX

TOP TOWER GROUND BAR: NO PROPOSED CHANGES

BOTTOM TOWER GROUND BAR:

#### SHELTER EXTERIOR SCOPE:

NO PROPOSED CHANGES

SHELTER COAX PORT: NO PROPOSED CHANGES

SHELTER EXTERIOR GROUND BAR: NO PROPOSED CHANGES

#### **SHELTER INTERIOR SCOPE:**

EXISTING EQUIPMENT: (2) EXISTING FXCB RRHs, (1) FRLB RRHs AND (2)

COMBINERS TO REMAIN IN SHELTER.

U.S. Cellular


8410 W. BRYN MAWR SUITE 700 CHICAGO, IL 60631 (773) 399-8900

PROJECT INFORMATION:

#### 568378 **SPANISH MT**


1600 OAK KNOLL ROAD UKIAH, CA 95482 (MENDOCINO COUNTY)



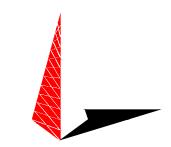

#### **TOWER ENGINEERING PROFESSIONALS**

326 TRYON ROAD RALEIGH, NC 27603-3530 OFFICE: (919) 661-6351 www.tepgroup.net

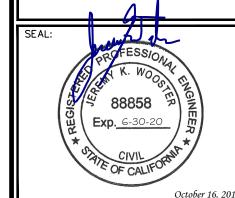

1	10-16-19	CONSTRUCTION
0	09-19-19	PRELIMINARY
REV	DATE	ISSUED FOR:

DRAWN BY: HH | CHECKED BY:

SHEET TITLE:

TITLE SHEET

SHEET NUMBER:

**REVISION:** 

TEP#: 52509

#### **BIRD'S EYE AERIAL OVERVIEW**




SITE OVERVIEW



**COMPOUND OVERVIEW** 

#### NOTE:

- 1. SURVEY DATED JUNE 5, 2000 BY ONTIVEROS & ASSOCIATES CONSULTING ENGINEERING & SURVEYORS. PROVIDED BY USCC.
- 2. SURVEY SHOWN ON THIS PAGE WAS PROVIDED BY ONTIVEROS & ASSOCIATES CONSULTING ENGINEERING & SURVEYORS AND IS NOT CARRIED UNDER SIGNATURE AND SEAL OF TOWER ENGINEERING PROFESSIONLS' SURVEYING SERVICES AND/OR ITS LAND SURVEYING PROFESSIONALS.

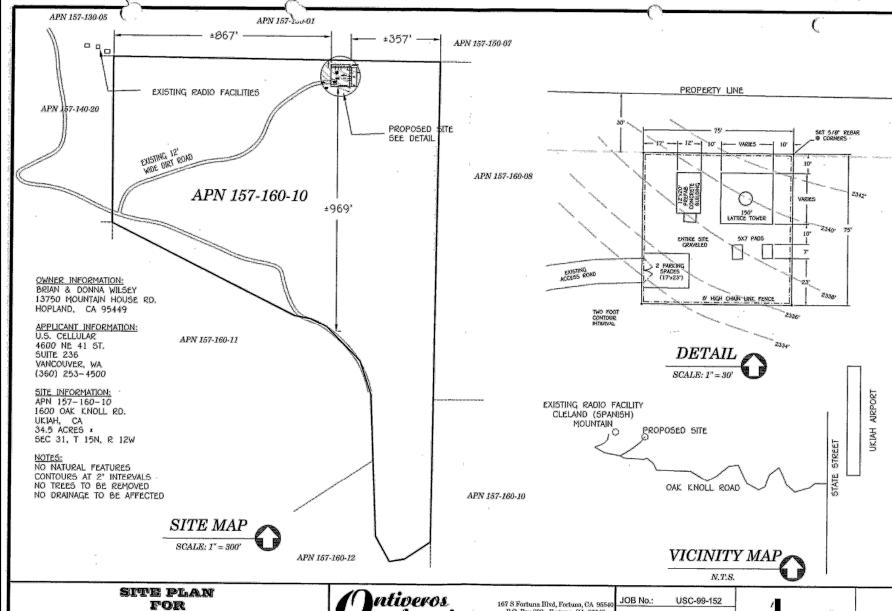

& Associates

P.O. Box 892 - Fortuna, CA 95540 Phone (707) 725-7410 FAX (707) 725-7411

DATE:

6/5/00

OF I

SITE SURVEY

U.S. CELLULAR

UKIAH, CA

SCALE: N.T.S

PLANS PREPARED FOR:




8410 W. BRYN MAWR SUITE 700 CHICAGO, IL 60631 (773) 399-8900

PROJECT INFORMATION:

#### 568378 SPANISH MT


1600 OAK KNOLL ROAD UKIAH, CA 95482 (MENDOCINO COUNTY)

PLANS PREPARED BY:

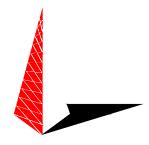

#### TOWER ENGINEERING PROFESSIONALS

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- 1	10-16-19	CONSTRUCTION
0	09-19-19	PRELIMINARY
REV	DATE	ISSUED FOR:

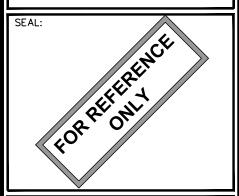DRAWN BY: HH CHECKED BY: JHB

SHEET TITLE:

SITE SURVEY

SHEET NUMBER:

REVISION:

TEP#: 52509




#### **COMPOUND VIEW "A"**



**COMPOUND VIEW "B"** 



**COMPOUND VIEW "C"** 

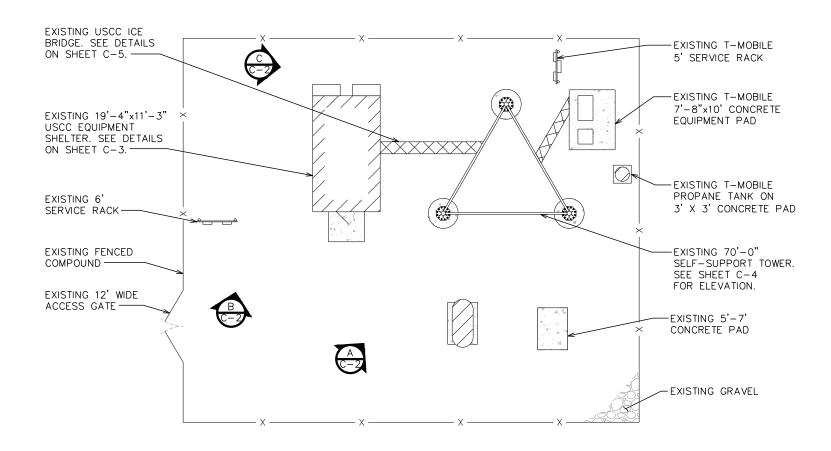

PLANS PREPARED FOR:

U.S. Cellular

8410 W. BRYN MAWR SUITE 700
CHICAGO, IL 60631


(773) 399-8900

PROJECT INFORMATION:

#### 568378 SPANISH MT

1600 OAK KNOLL ROAD UKIAH, CA 95482 (MENDOCINO COUNTY)



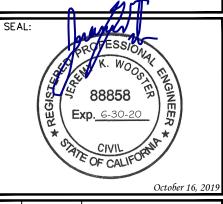

- 1	10-16-19	CONSTRUCTION
0	09-19-19	PRELIMINARY
REV	DATE	ISSUED FOR:

DRAWN BY: HH CHECKED BY: JHB

SHEET TITLE:

# COMPOUND DETAIL

SHEET NUMBER:


REVISION:

TEP#: 52509

**COMPOUND DETAIL** 

SCALE:  $\frac{1}{16}$ " = 1'-0"

SCALE IN FEET

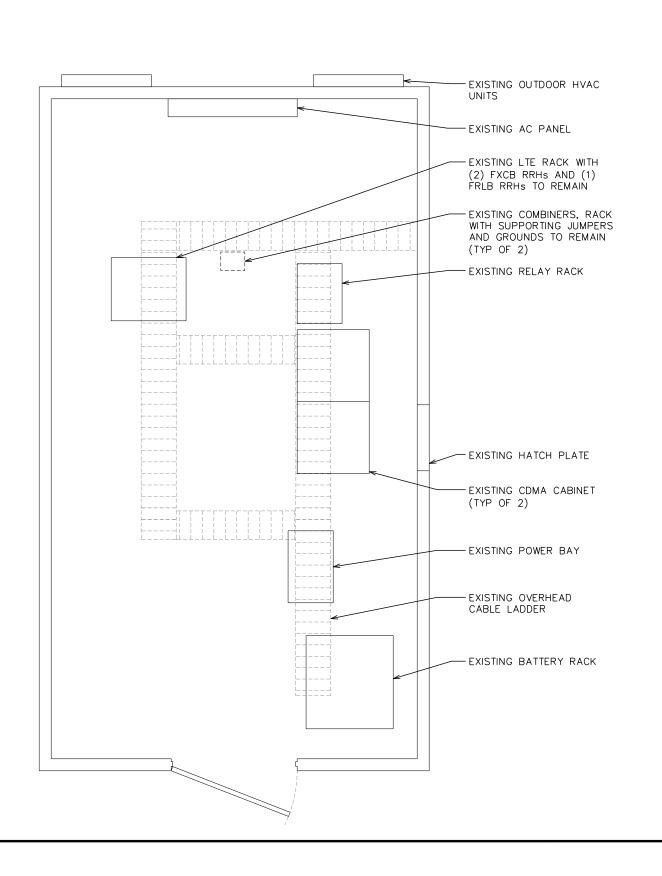

PLANS PREPARED FOR:




8410 W. BRYN MAWR SUITE 700 CHICAGO, IL 60631 (773) 399-8900

PROJECT INFORMATION:

#### 568378 SPANISH MT

1600 OAK KNOLL ROAD UKIAH, CA 95482 (MENDOCINO COUNTY)

PLANS PREPARED BY:

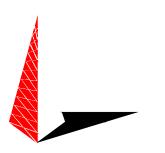

#### TOWER ENGINEERING PROFESSIONALS

326 TRYON ROAD RALEIGH, NC 27603-3530 OFFICE: (919) 661-6351 www.tepgroup.net

SEAL:

PROFESSIONAR ENGINEER

88858

Exp. 6-30-20

\*\*

CIVIL OF CALIFORNIA\*\*

- 1	10-16-19	CONSTRUCTION
0	09-19-19	PRELIMINARY
REV	DATE	ISSUED FOR:

October 16, 2019

DRAWN BY: HH CHECKED BY: JHB

SHEET TITLE:

SHELTER DETAILS


SHEET NUMBER:

REVISION:

**TEP#:** 52509

**EXISTING SHELTER LAYOUT** 


SCALE: N.T.S.

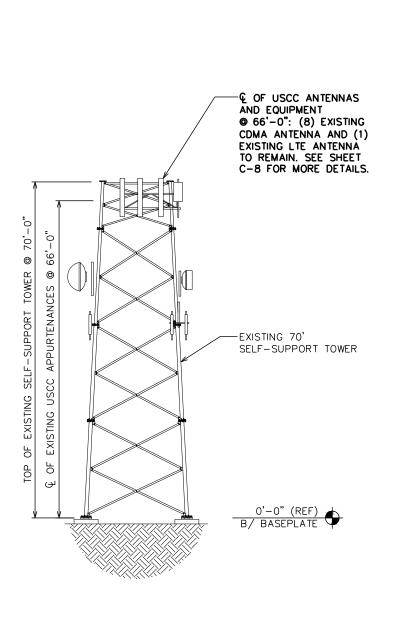





**EXISTING USCC LTE TAG** 

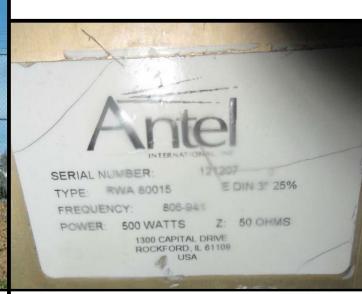

**EXISTING USCC CDMA TAG** 




8410 W. BRYN MAWR SUITE 700 CHICAGO, IL 60631 (773) 399-8900

PROJECT INFORMATION:

#### 568378 **SPANISH MT**


1600 OAK KNOLL ROAD UKIAH, CA 95482 (MENDOCINO COUNTY)

PLANS PREPARED BY:

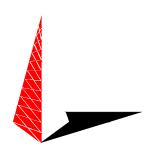

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-	10-16-19	CONSTRUCTION
0	09-19-19	PRELIMINARY
REV	DATE	ISSUED FOR:

DRAWN BY: HH CHECKED BY:

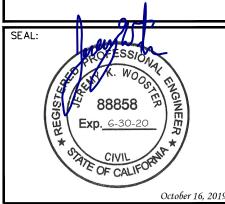SHEET TITLE:

**TOWER ELEVATION** 

SHEET NUMBER:

REVISION:


TEP#: 52509


**EXISTING TOWER ELEVATION** 20 SCALE: 1" = 20' SCALE IN FEET

**EXISTING TOWER ELEV.** 



- 1. ALL VIEWS ARE LOOKING FROM THE TOWER TOWARDS THE SHELTER.
- 2. ANALOG COAX (IF APPLICABLE) TO BE REMOVED IS LABELED WITH GREEN TAPE.

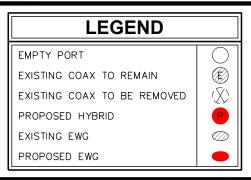

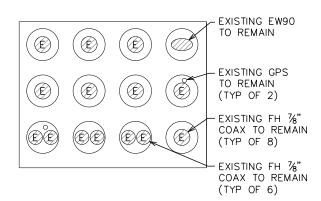

# 03/20/2018 16:54

#### **EXISTING HATCH PLATE**

SCALE: N.T.S.



#### **EXISTING ICE BRIDGE**

SCALE: N.T.S.



U.S. Cellular


8410 W. BRYN MAWR SUITE 700 CHICAGO, IL 60631 (773) 399-8900

PROJECT INFORMATION:

#### 568378 SPANISH MT


1600 OAK KNOLL ROAD UKIAH, CA 95482 (MENDOCINO COUNTY)

PLANS PREPARED BY:

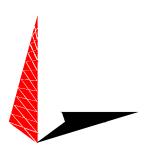

#### **TOWER ENGINEERING PROFESSIONALS**

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DRAWN BY: HH CHECKED BY: JHB

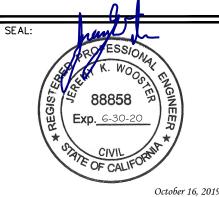SHEET TITLE:

HATCH PLATE & ICE BRIDGE DETAILS

SHEET NUMBER:


REVISION:

**C-5** 

TEP#: 52509


#### **EXISTING HATCH PLATE LAYOUT**

SCALE: N.T.S.

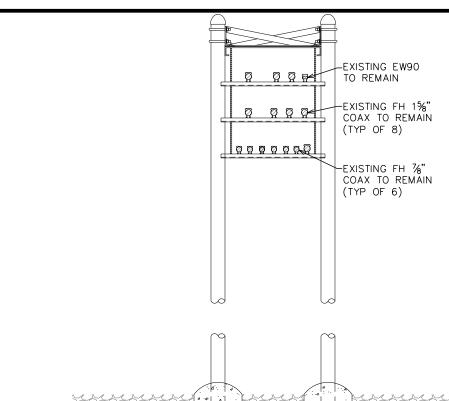

#### **EXISTING ICE BRIDGE CONFIGURATION**

SCALE: N.T.S.

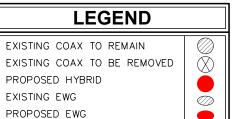



**USCC WAVEGUIDE** 

SAFETY CLIMB-EXISTING USCC EW90 TO REMAIN--EXISTING FH %" COAX BY OTHERS TO REMAIN (TYP OF 6) EXISTING USCC FH %" COAX TO REMAIN
(TYP OF 8) -EXISTING HYBRID 1¾" CABLE BY OTHERS TO REMAIN EXISTING USCC FH %"
COAX TO REMAIN -EXISTING SM 78" COAX BY OTHERS TO REMAIN (TYP OF 3) (TYP OF 6)-WAVEGUIDE #2 240° 120° WAVEGUIDE #1

PLANS PREPARED FOR: U.S. Cellular 8410 W. BRYN MAWR SUITE 700 CHICAGO, IL 60631 (773) 399-8900

PROJECT INFORMATION:

#### 568378 **SPANISH MT**

1600 OAK KNOLL ROAD UKIAH, CA 95482 (MENDOCINO COUNTY)

PLANS PREPARED BY:



#### **TOWER ENGINEERING PROFESSIONALS**

326 TRYON ROAD RALEIGH, NC 27603-3530 OFFICE: (919) 661-6351 www.tepgroup.net

SEAL: 88858 Exp. 6-30-20 October 16, 2019

1	10-16-19	CONSTRUCTION
0	09-19-19	PRELIMINARY
REV	DATE	ISSUED FOR:

DRAWN BY: HH CHECKED BY:

SHEET TITLE:

**COAX LAYOUT** 

SHEET NUMBER:

REVISION:

TEP#: 52509

**EXISTING COAX LAYOUT** 

SCALE:  $\frac{1}{2}$ " = 1'-0"

**LEGEND** 

SCALE: N.T.S.

SCALE IN FEET




**EXISTING INSIDE SHELTER** 

SCALE: N.T.S.




**EXISTING OUTSIDE SHELTER** 

SCALE: N.T.S.

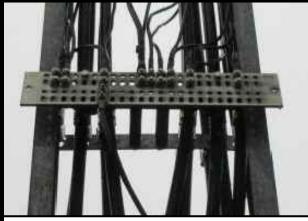


**EXISTING BOTTOM TOWER** 

SCALE: N.T.S.

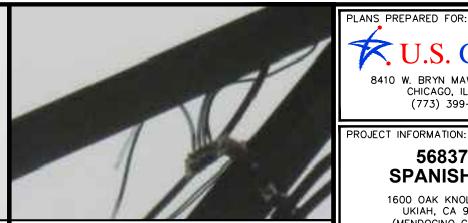

SCALE: N.T.S.

(MENDOCINO COUNTY) PLANS PREPARED BY:

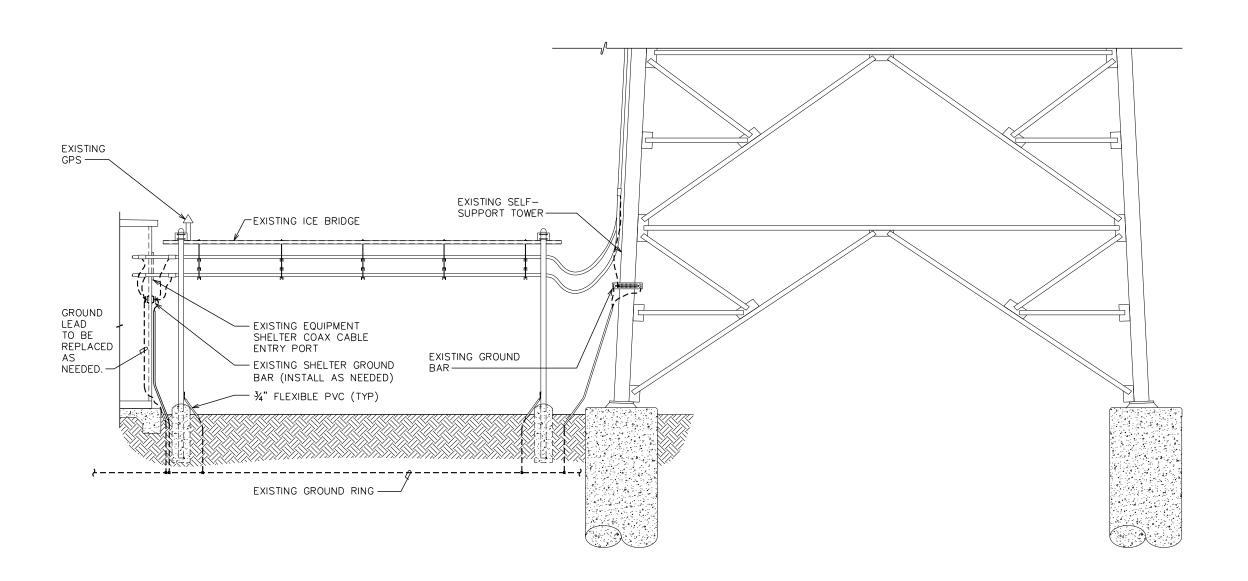



U.S. Cellular


8410 W. BRYN MAWR SUITE 700 CHICAGO, IL 60631 (773) 399-8900

568378 **SPANISH MT** 

1600 OAK KNOLL ROAD UKIAH, CA 95482

#### **TOWER ENGINEERING PROFESSIONALS**

326 TRYON ROAD RALEIGH, NC 27603-3530 OFFICE: (919) 661-6351 www.tepgroup.net

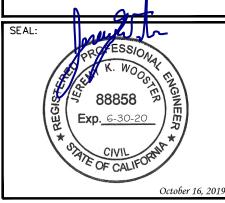

- 1	10-16-19	CONSTRUCTION
0	09-19-19	PRELIMINARY
REV	DATE	ISSUED FOR:

DRAWN BY: HH CHECKED BY:

SHEET TITLE:

**GROUND BAR DETAILS** 

SHEET NUMBER:


REVISION:

TEP#: 52509

**SIDE VIEW** 

# LEGEND

EXISTING CDMA PANEL TO REMAIN
EXISTING LTE PANEL TO BE REMOVED
EXISTING EQUIPMENT TO REMAIN

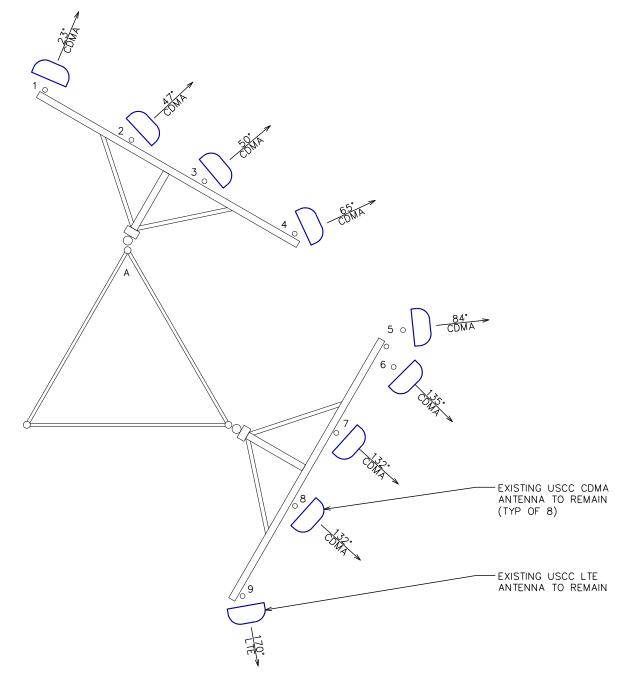

	EXISTING LOADING													
	ANTENNAS CABLES TOWER TOP RELATED EQUIPMENT													
SECTOR	ANTENNA POSITION NUMBER	MANUFACTURER/ MODEL NUMBER	ELEC. D-TILT	MECH. D-TILT	TECH	BAND	CABLE TYPE	COAX	CABLE QTY.	CABLE LENGTH	TOP C-BIAS	RRH	RAYCAP	ANTENNA NOTES
ALPHA	1	ANTEL BXA 80040/4	0,	1.2*	CDMA	B5	COAX	<b>%</b> "	2	76'-3"	-	-	-	TO REMAIN
ALPHA	2	ANTEL BWB 80016/90	0.	0.3*	CDMA	B5	COAX	%"	2	72'-3"	-	-	-	TO REMAIN
ALPHA	3	ANTEL RWB 80016/90	0,	0.4*	CDMA	B5	COAX	<b>%</b> "	1	72'-3 <b>"</b>	-	-	-	TO REMAIN
ALPHA	4	ANTEL RWB 80016/90	0.	0.2*	CDMA	B5	COAX	<b>%</b> "	1	80'-3"	-	-	-	TO REMAIN
BETA	5	ANTEL BXA 80040/4	0,	0.2*	CDMA	B5	COAX	<b>%</b> "	2	91'-3"	-	-	-	TO REMAIN
BETA	6	BXA 80040/4	0,	4.2*	CDMA	B5	COAX	%"	2	91'-3"	-	-	-	TO REMAIN
BETA	7	ANTEL RWA 80015	0.	0.8*	CDMA	B5	COAX	%"	1	91'-3"	-	-	-	TO REMAIN
BETA	8	ANTEL RWA 80015	0,	0.4*	CDMA	B5	COAX	76°	1	90'-3 <b>"</b>	-	-	-	TO REMAIN
BETA	9	AM-X-CW-18-65-00T-RET	0.	0.	LTE	B5/B12	COAX	%"	2	100'-0"	1	-	-	TO REMAIN

PLANS PREPARED FOR:


U.S. Cellular

8410 W. BRYN MAWR SUITE 700
CHICAGO, IL 60631
(773) 399-8900


PROJECT INFORMATION:

#### 568378 SPANISH MT

1600 OAK KNOLL ROAD UKIAH, CA 95482 (MENDOCINO COUNTY)

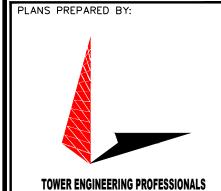

326 TRYON ROAD
RALEIGH, NC 27603-3530
OFFICE: (919) 661-6351
www.tepgroup.net

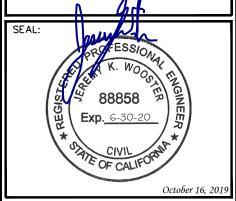

1	10-16-19	CONSTRUCTION
0	09-19-19	PRELIMINARY
REV	DATE	ISSUED FOR:

DRAWN BY: HH CHECKED BY: JHB

SHEET TITLE:

# ANTENNA MOUNTING DETAILS

SHEET NUMBER:

SCALE IN FEET

REVISION:

TEP#: 52509

**EXISTING ANTENNA ASSIGNMENT** 

SCALE:  $\frac{1}{8}$ " = 1'-0"

#### **GENERAL NOTES:**


- 1. ALL REFERENCES TO OWNER IN THESE DOCUMENTS SHALL BE CONSIDERED U.S. CELLULAR OR IT'S DESIGNATED REPRESENTATIVE.
- 2. ALL WORK PRESENTED ON THESE DRAWINGS MUST BE COMPLETED BY THE CONTRACTOR UNLESS NOTED OTHERWISE. THE CONTRACTOR MUST HAVE CONSIDERABLE EXPERIENCE IN PERFORMANCE OF WORK SIMILAR TO THAT DESCRIBED HEREIN. BY ACCEPTANCE OF THIS ASSIGNMENT, THE CONTRACTOR IS ATTESTING THAT HE DOES HAVE SUFFICIENT EXPERIENCE AND ABILITY, THAT HE IS KNOWLEDGEABLE OF THE WORK TO BE PERFORMED AND THAT HE IS PROPERLY LICENSED AND PROPERLY REGISTERED TO DO THIS WORK IN THE STATE OF CALIFORNIA.
- 3. STRUCTURE IS DESIGNED IN ACCORDANCE WITH ANSI/TIA-222-G, 2005, FOR A 85 MPH 3-SECOND GUST WIND LOAD. THIS CONFORMS TO THE REQUIREMENTS OF THE CALIFORNIA BUILDING CODE, 2016 EDITION.
- 4. WORK SHALL BE COMPLETED IN ACCORDANCE WITH THE CALIFORNIA BUILDING CODE, 2016 EDITION.
- 5. UNLESS SHOWN OR NOTED OTHERWISE ON THE CONTRACT DRAWINGS, OR IN THE SPECIFICATIONS, THE FOLLOWING NOTES SHALL APPLY TO THE MATERIALS LISTED HEREIN, AND TO THE PROCEDURES TO BE USED ON THIS PROJECT.
- 6. ALL HARDWARE ASSEMBLY MANUFACTURER'S INSTRUCTIONS SHALL BE FOLLOWED EXACTLY AND SHALL SUPERCEDE ANY CONFLICTING NOTES ENCLOSED HEREIN.
- 7. IT IS THE CONTRACTOR'S SOLE RESPONSIBILITY TO DETERMINE ERECTION PROCEDURE AND SEQUENCE TO INSURE THE SAFETY OF THE STRUCTURE AND IT'S COMPONENT PARTS DURING ERECTION AND/OR FIELD MODIFICATIONS. THIS INCLUDES, BUT IS NOT LIMITED TO, THE ADDITION OF TEMPORARY BRACING, GUYS OR TIE DOWNS THAT MAY BE NECESSARY. SUCH MATERIAL SHALL BE REMOVED AND SHALL REMAIN THE PROPERTY OF THE CONTRACTOR AFTER THE COMPLETION OF THE PROJECT.
- 8. ALL DIMENSIONS, ELEVATIONS, AND EXISTING CONDITIONS SHOWN ON THE DRAWINGS SHALL BE FIELD VERIFIED BY THE CONTRACTOR PRIOR TO BEGINNING ANY MATERIALS ORDERING, FABRICATION OR CONSTRUCTION WORK ON THIS PROJECT. CONTRACTOR SHALL NOT SCALE CONTRACT DRAWINGS IN LIEU OF FIELD VERIFICATIONS. ANY DISCREPANCIES SHALL BE IMMEDIATELY BROUGHT TO THE ATTENTION OF THE OWNER AND THE OWNER'S ENGINEER. THE DISCREPANCIES MUST BE RESOLVED BEFORE THE CONTRACTOR IS TO PROCEED WITH THE WORK. THE OWNER SHALL HAVE A SET OF APPROVED. PLANS AVAILABLE AT THE SITE AT ALL TIMES WHILE WORK IS BEING PERFORMED. A DESIGNATED RESPONSIBLE EMPLOYEE SHALL BE AVAILABLE FOR CONTACT BY GOVERNING AGENCY INSPECTORS. THE CONTRACT DOCUMENTS DO NOT INDICATE THE METHOD OF CONSTRUCTION. THE CONTRACTOR SHALL SUPERVISES AND DIRECT THE WORK AND SHALL BE SOLELY RESPONSIBLE FOR ALL CONSTRUCTION MEANS, METHODS, TECHNIQUES, SEQUENCES, AND PROCEDURES. OBSERVATION VISITS TO THE SITE BY THE OWNER AND/OR THE ENGINEER SHALL NOT INCLUDE INSPECTION OF THE PROTECTIVE MEASURES OR THE PROCEDURES.
- 9. ALL MATERIALS AND EQUIPMENT FURNISHED SHALL BE NEW AND OF GOOD QUALITY, FREE FROM FAULTS AND DEFECTS AND IN CONFORMANCE WITH THE CONTRACT DOCUMENTS. ANY AND ALL SUBSTITUTIONS MUST BE PROPERLY APPROVED AND AUTHORIZED IN WRITING BY THE OWNER AND ENGINEER PRIOR TO INSTALLATION. THE CONTRACTOR SHALL FURNISH SATISFACTORY EVIDENCE AS TO THE KIND AND QUALITY OF THE MATERIALS AND EQUIPMENT BEING SUBSTITUTED.
- 10. THE CONTRACTOR SHALL BE RESPONSIBLE FOR INITIATING, MAINTAINING, AND SUPERVISING ALL SAFETY PRECAUTIONS AND PROGRAMS IN CONNECTION WITH THE WORK. THE CONTRACTOR IS RESPONSIBLE FOR INSURING THAT THIS PROJECT AND RELATED WORK COMPLIES WITH ALL APPLICABLE LOCAL, STATE, AND FEDERAL SAFETY CODES AND REGULATIONS GOVERNING THIS WORK
- 11. ACCESS TO THE PROPOSED WORK SITE MAY BE RESTRICTED. THE CONTRACTOR SHALL COORDINATE INTENDED CONSTRUCTION ACTIVITY, INCLUDING WORK SCHEDULE AND MATERIALS ACCESS, WITH THE RESIDENT LEASING AGENT FOR APPROVAL.
- 12. BILL OF MATERIALS AND PART NUMBERS LISTED ON CONSTRUCTION DRAWINGS ARE INTENDED TO AID CONTRACTOR. CONTRACTOR SHALL VERIFY PARTS AND QUANTITIES WITH MANUFACTURER PRIOR TO BIDDING AND/OR ORDERING MATERIALS.
- 13. ALL PERMITS THAT MUST BE OBTAINED ARE THE RESPONSIBILITY OF THE CONTRACTOR. THE CONTRACTOR WILL BE RESPONSIBLE FOR ABIDING BY ALL CONDITIONS AND REQUIREMENTS OF THE PERMITS.
- 14. 24 HOURS PRIOR TO THE BEGINNING OF ANY CONSTRUCTION, THE CONTRACTOR MUST NOTIFY THE APPLICABLE JURISDICTIONAL (STATE, COUNTY OR CITY) ENGINEER.
- 15. THE CONTRACTOR SHALL REWORK (DRY, SCARIFY, ETC.) ALL MATERIAL NOT SUITABLE FOR SUBGRADE IN IT PRESENT STATE. AFTER REWORKING, IF THE MATERIAL REMAINS UNSUITABLE, THE CONTRACTOR SHALL UNDERCUT THIS MATERIAL AND REPLACE WITH APPROVED MATERIAL. ALL SUBGRADES SHALL BE PROOFROLLED WITH A FULLY LOADED TANDEM AXLE DUMP TRUCK PRIOR TO PAVING. ANY SOFTER MATERIAL SHALL BE REWORKED OR REPLACED.

#### STRUCTURAL STEEL NOTES:

- 1. THE FABRICATION AND ERECTION OF STRUCTURAL STEEL SHALL CONFORM TO THE AISC SPECIFICATIONS AND MANUAL OF STEEL CONSTRUCTION, 14TH EDITION.
- 2. UNLESS OTHERWISE NOTED, ALL STRUCTURAL ELEMENTS SHALL CONFORM TO THE FOLLOWING REQUIREMENTS:
  - A. STRUCTURAL STEEL, ASTM DESIGNATION A36 OR GR50.
  - B. ALL BOLTS, ASTM A325 TYPE I GALVANIZED HIGH STRENGTH BOLTS.
  - C. ALL NUTS, ASTM A563 CARBON AND ALLOY STEEL NUTS.
  - D. ALL WASHERS, ASTM F436 HARDENED STEEL WASHERS.
- 3. ALL CONNECTIONS NOT FULLY DETAILED ON THESE PLANS SHALL BE DETAILED BY THE STEEL FABRICATOR IN ACCORDANCE WITH AISC SPECIFICATIONS AND MANUAL OF STEEL CONSTRUCTION, 13TH EDITION.
- 4. HOLES SHALL NOT BE FLAME CUT THRU STEEL UNLESS APPROVED BY THE ENGINEER.
- 5. HOT-DIP GALVANIZE ALL ITEMS UNLESS OTHERWISE NOTED, AFTER FABRICATION WHERE PRACTICABLE. GALVANIZING: ASTM A123, ASTM, A153/A153M OR ASTM A653/A653M, G90, AS APPLICABLE.
- 6. REPAIR DAMAGED SURFACES WITH GALVANIZING REPAIR METHOD AND PAINT CONFORMING TO ASTM A780 OR BY APPLICATION OF STICK OR THICK PASTED MATERIAL SPECIFICALLY DESIGNED FOR REPAIR OF GALVANIZING. CLEAN AREAS TO BE REPAIRED AND REMOVE SLAG FROM WELDS. HEAT SURFACES TO WHICH STICK OR PASTE MATERIAL IS APPLIED, WITH A TORCH TO A TEMPERATURE SUFFICIENT TO MELT THE METALLICS IN STICK OR PASTED; SPREAD MOLTEN MATERIAL UNIFORMLY OVER SURFACES TO BE COATED AND WIPE OFF EXCESS MATERIAL.
- 7. A NUT LOCKING DEVICE SHALL BE INSTALLED ON ALL PROPOSED AND/OR REPLACED BOLTS.
- 8. ALL PROPOSED AN/OR REPLACED BOLTS SHALL BE OF SUFFICIENT LENGTH TO EXCLUDE THE THREADS FROM THE SHEAR PLANE.
- ALL PROPOSED AND/OR REPLACED BOLTS SHALL BE OF SUFFICIENT LENGTH SUCH THAT THE END OF THE BOLT BE AT LEAST FLUSH WITH THE FACE OF THE NUT. IT IS NOT PERMITTED FOR THE BOLT END TO BE BELOW THE FACE OF THE NUT AFTER TIGHTENING IS COMPLETED.
- 10. ALL ASSEMBLY AND ANCHOR BOLTS ARE TO BE TIGHTENED TO A "SNUG TIGHT" CONDITION AS DEFINED IN SECTION 8.1 OF THE AISC, "SPECIFICATION FOR STRUCTURAL JOINTS USING ASTM A325 OR A490 BOLTS", DATED JUNE 30, 2004.
- 11. FLAT WASHERS ARE TO BE INSTALLED WITH BOLTS OVER SLOTTED HOLES.
- 12. DO NOT OVER TORQUE ASSEMBLY BOLTS. GALVANIZING ON BOLTS, NUTS, AND STEEL PARTS; MAY ACT AS A LUBRICANT, THUS OVER TIGHTENING MAY OCCUR AND MAY CAUSE BOLTS TO CRACK AND SNAP OFF.
- 13. PAL NUTS ARE TO BE INSTALLED AFTER NUTS ARE TIGHT AND WITH EDGE LIP OUT. PAL NUTS ARE NOT REQUIRED WHEN SELF-LOCKING NUTS ARE PROVIDED.
- 14. GALVANIZED ASTM A325 BOLTS SHALL NOT BE REUSED.
- 15. ALL WELDING SHALL BE IN ACCORDANCE WITH THE AWS D1.1: 2010, STRUCTURAL WELDING CODE-REINFORCING STEEL. ALL WELDERS SHALL DISPLAY PROPER CERTIFICATION OF QUALIFICATION.

#### **GROUNDING NOTES:**

- ALL CADWELD CONNECTIONS TO GALVANIZED MATERIAL SHALL BE PROPERLY PREPARED TO ASSURE A SATISFACTORY CADWELD.
- 2. CADWELD CONNECTION SHALL BE COATED WITH COLD GALVANIZING SPRAY.
- 3. ALL VERTICAL JUMPERS SHALL NOT BE WELDED WITHIN TWO FT OF THE GROUND ROD.
- 4. SECTOR GROUNDING DIAGRAM:

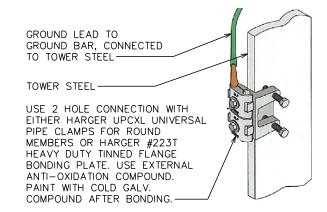



(773) 399-8900


PROJECT INFORMATION:

#### 568378 SPANISH MT

1600 OAK KNOLL ROAD UKIAH, CA 95482 (MENDOCINO COUNTY)



326 TRYON ROAD RALEIGH, NC 27603-3530 OFFICE: (919) 661-6351 www.tepgroup.net

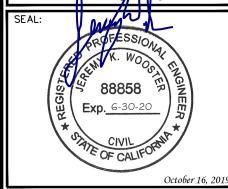

	10-16-19	CONSTRUCTION
0	09-19-19	PRELIMINARY
REV	DATE	ISSUED FOR:

DRAWN BY: HH CHECKED BY: JHB

SHEET TITLE:

GENERAL NOTES

SHEET NUMBER:

REVISION:

TEP#: 52509