

## COUNTY OF MENDOCINO DEPARTMENT OF PLANNING AND BUILDING SERVICES

860 North Bush Street · Ukiah · California · 95482 120 West Fir Street · Ft. Bragg · California · 95437 BRENT SCHULTZ, DIRECTOR
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pbs@mendocinocounty.org
www.mendocinocounty.org/pbs

#### February 4, 2019

Planning – Fort Bragg Department of Transportation Environmental Health - Fort Bragg Building Inspection - Fort Bragg Emergency Services Assessor Air Quality Management Sonoma State University
Department of Forestry/ CalFire
Department of Fish and Wildlife
US Fish & Wildlife Service
Coastal Commission
RWQCB
Pacific Gas & Electric

Gualala Municipal Advisory Council South Coast Fire District Cloverdale Rancheria Redwood Valley Rancheria Sherwood Valley Band of Pomo Indians

**CASE#**: U\_2018-0020 **DATE FILED**: 9/6/2018

**OWNER: ARENA ELEMENTARY SCHOOL DISTRICT** 

APPLICANT: AT&T AGENT: EPIC WIRELESS

**REQUEST:** Coastal Development Use Permit to construct a new telecommunications facility within a 2,025 sq. ft. lease area. The site is proposed to consist of a 123 ft. tall lattice type tower with 12 panel antennae, 24 radio units, 4 surge supressors along with various appurtenant equipment, a diesel electricity generator with a 54 gallon diesel fuel tank for backup power needs and ground mounted equipment cabinets within the fenced-in lease area to facilitate the operations of the cell tower. Access to the lease area is to be via an existing asphalt driveway accessed from Old Stage Road.

LOCATION: 1± miles northeast of the town of Gualala, more specifically 530± ft. south of the intersection of Old Stage

Road (CR 502) and Moonrise Drive (CR 514C), located at 39290 Old Stage Rd., Gualala (APN: 145-091-22).

**STAFF PLANNER:** KEITH GRONENDYKE **RESPONSE DUE DATE:** February 19, 2019

#### PROJECT INFORMATION CAN BE FOUND AT:

https://www.mendocinocounty.org/government/planning-building-services/public-agency-referrals

Mendocino County Planning & Building Services is soliciting your input, which will be used in staff analysis and forwarded to the appropriate public hearing. You are invited to comment on any aspect of the proposed project(s). Please convey any requirements or conditions your agency requires for project compliance to the project coordinator at the above address, or submit your comments by email to <a href="mailto:pbs@mendocinocounty.org">pbs@mendocinocounty.org</a>. Please note the case number and name of the project coordinator with all correspondence to this department.

We have reviewed the above applica	ation and recommend the followi	ng (please check one):		
☐ No comment at this time.				
☐ Recommend conditional approva	Recommend conditional approval (attached).			
Applicant to submit additional information (attach items needed, or contact the applicant directly, copying Planning and Building Services in any correspondence you may have with the applicant)				
Recommend denial (Attach reasons for recommending denial).				
☐ Recommend preparation of an Er	Recommend preparation of an Environmental Impact Report (attach reasons why an EIR should be required).			
Other comments (attach as necessary).				
REVIEWED BY:				
Signature	Department	Date		

REPORT FOR: COASTAL DEVELOPMENT USE PERMIT CASE #: U 2018-0020

OWNER: ARENA UNION ELEMENTARY SCHOOL DISTRICT

**APPLICANT**: AT&T MOBILITY

**AGENT:** EPIC WIRELESS GROUP, LLC/JARED KEARSLY

REQUEST: Coastal Development Use Permit to construct a new telecommunications facility within a 2,025 sq. ft.

lease area. The site is proposed to consist of a 123 ft. tall lattice type tower with 12 panel antennae, 24 radio units, 4 surge supressors along with various appurtenant equipment, a diesel electricity generator with a 54 gallon diesel fuel tank for backup power needs and ground mounted equipment cabinets within the fenced-in lease area to facilitate the operations of the cell tower. Access to the lease area is to be via

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Road (CR 502) and Moonrise Drive (CR 514C), located at 39290 Old Stage Rd., Gualala (APN: 145-

091-22).

ACREAGE: 10.5± acres

GENERAL PLAN: RMR40 ZONING: RMR40 COASTAL ZONE: YES

**EXISTING USES:** School bus parking SUPERVISORIAL DISTRICT: 5

TOWNSHIP: 11N RANGE: 15W SECTION: 22 USGS QUAD#: 70

RELATED CASES ON SITE: U 2004-0010 Use Permit to construct a K-5 elementary school. Project was not

constructed.

**RELATED CASES IN VICINITY:** None found

	ADJACENT GENERAL PLAN	ADJACENT ZONING	ADJACENT LOT SIZES	ADJACENT USES
NORTH:	Rural Residential (RR 5)	Rural Residential (RR 5)	3.5±A	Residential/PG&E substation
EAST:	Rural Residential (RR 5) and Rural Residential (RR 40)	Rural Residential (RR 5) and Rural Residential (RR 40)	.35±A to 5±A	Agricultural/Residential
SOUTH:	Remote Residential (RMR 40)	Remote Residential (RMR 40)	±40A to76±A	Vacant
WEST:	Remote Residential (RMR40)	Remote Residential (RMR40)	16.5±A	Vacant

REFERRAL AGENCIES:		
⊠Planning (FB )	☐ Trails Advisory Council	☐ CHP
☑Department of Transportation	□ Native Plant Society	
⊠Environmental Health (FB)	☐ State Clearinghouse	☐ County Addresser
⊠Building Inspection ( FB)	☐ Caltrans	LAFCO
⊠Emergency Services	⊠ CalFire	⊠Gualala MAC
⊠Assessor	□ Department of Fish & Wildlife	□Laytonville MAC
☐Farm Advisor		□ Westport MAC
☐Agriculture Commissioner	⊠ RWQCB	☐ Sierra Club
⊠Cloverdale Rancheria	☐ Division of Mines & Geology	☐Arena Union School District
⊠Air Quality Management District	☐ Department of Health Services	Sewer District
□ALUC	☐ Department of Parks & Recreation	☐ Water District
☐County Water Agency	☐ Department of Conservation	⊠Fire District South Coast
⊠PG&E	☐ Soil Conservation Service	☐ Community Svcs
Sonoma State University	☐ Army Corps of Engineers	☐ City Planning
□ US Fish & Wildlife Service	Sherwood Valley Band of Pomo Indians	-
□ Redwood Valley Rancheria	-	
☐ Russian River Flood Control/Water Cons	ervation Improvement District	

**ADDITIONAL INFORMATION:** The applicant has submitted a Biological Resource Assessment dated December 10, 2018 for the project site. As a result of this assessment, the original project location for the cell tower has been relocated approximately seventy-feet to the south.


**ASSESSOR'S PARCEL #:** 145-091-22


STAFF PLANNER: Keith Gronendyke DATE: 1/02/2019

## **ENVIRONMENTAL DATA** (To be completed by Planner)

	NI -		COUNTY WIDE		
Yes N	No O	1.	Alquist-Priolo Earthquake Fault Zone – Geotechnical Report #GS		
NO	0	2. Floodplain/Floodway Map –Flood Hazard Development Permit #FP			
NO /	NO	3.	Within/Adjacent to Agriculture Preserve / Timberland Production		
NO	0	4.	Within/Near Hazardous Waste Site		
N	0	5.	Natural Diversity Data Base		
NO	0	6.	Airport CLUP Planning Area – ALUC#		
	$\boxtimes$	7.	Adjacent to State Forest/Park/Recreation Area.		
	$\boxtimes$	8.	Adjacent to Equestrian/Hiking Trail.		
	$\boxtimes$	9.	Hazard/Landslides Map		
	$\boxtimes$	10.	Require Water Efficient Landscape Plan.		
	$\boxtimes$	11.	Biological Resources/Natural Area Map.		
$\boxtimes$		12.	Fire Hazard Severity Classification: ☐ LRA ☐ SRA-CDF# 88-18		
$\boxtimes$		13.	Soil Type(s) Western soils		
	$\boxtimes$	14.	Wild and Scenic River.		
	$\boxtimes$	15.	Specific Plan Area.		
	$\boxtimes$	16.	State Permitting Required/State Clearinghouse Review		
	$\boxtimes$	17.	Oak Woodland Area		
Vaa	Na		COASTAL ZONE		
Yes YE	No S	16.	Exclusion Map.		
YE	S	17.	Coastal Groundwater Study Zone.		
NO	0	18.	Critical Water Resources Bedrock  Highly Scenic Area/Special Communities.		
	$\boxtimes$	19.	Land Capabilities/Natural Hazards Map.		
		20.	Moderate and High Timberland Productivity; Bedrock Seismicity  Habitats/ESHA/Resources Map.		
		21.	Appealable Area/Original Jurisdiction Map.		
	$\boxtimes$	22.	Blayney-Dyett Map.		
	$\boxtimes$	23.	Ocean Front Parcel (Blufftop Geology).		
	$\boxtimes$	24.	Adjacent to beach/tidelands/submerged land/Public Trust Land.		
	$\boxtimes$	25.	Noyo Harbor/Albion Harbor.		



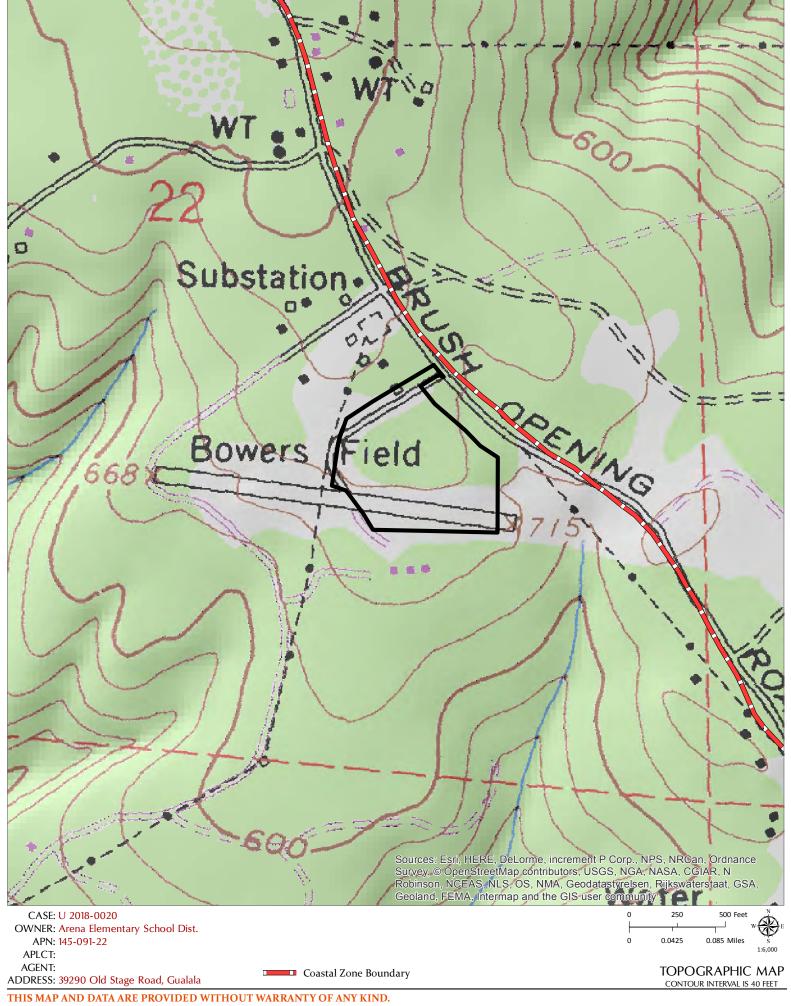

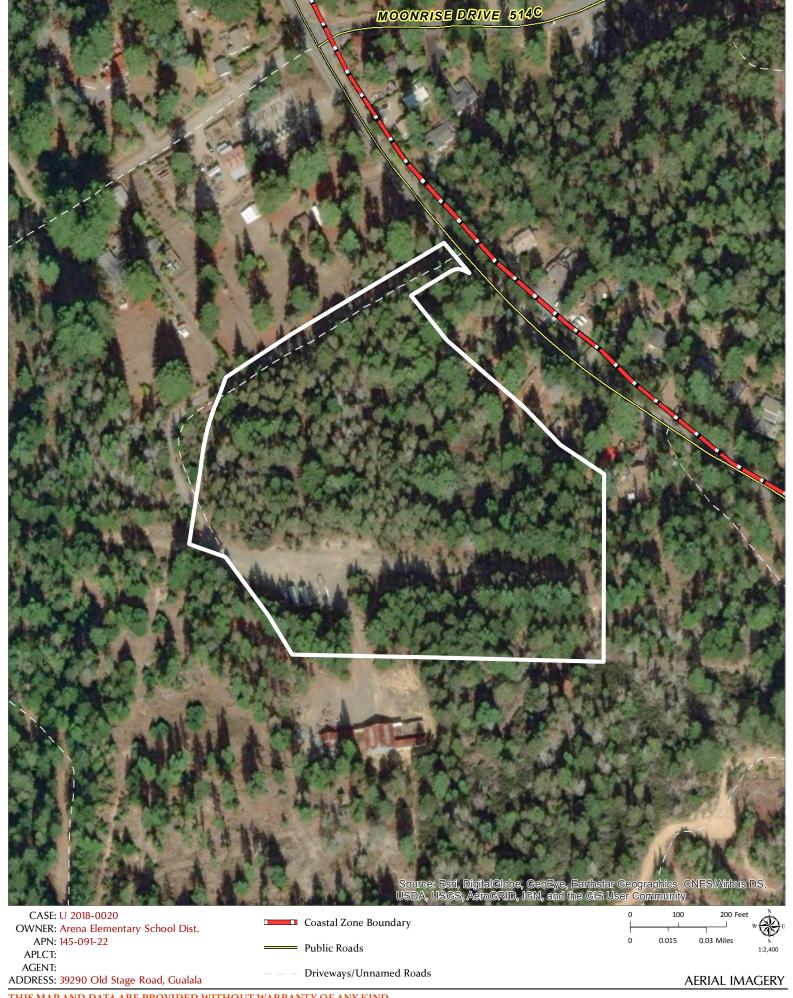

## COUNTY OF MENDOCINO DEPT OF PLANNING AND BUILDING SERVICES

120 WEST FIR STREET FORT BRAGG, CA 95437 Telephone: 707-964-5379 FAX: 707-961-2427 pbs@co.mendocino.ca.us

www.co.mendocino.ca.us/planning



Case No(s)	U-2018-0020
CDF No(s)	
Date Filed	***************************************
Fee	-1
Receipt No.	The state of the s
Received by	
	Office Use Only

lame	AT&T Mobility			
Mailing Address	5001 Executive F	Parkway		
City	San Ramon	State CA	Zip Code 94583	Phone (415) 260-5617
— P	ROPERTY OWN		nt-int	
Name Mailing Address	D.O. Pay 97	mentary School Dis	STRICT	
City	Point Arena	State CA	Zip Code 95468	Phone (707) 882-2803
	GEL SIZE ————————————————————————————————————	e feet	ADDRESS OF PROJE d Stage Rd., Gualala, C	
10.5				
	SECCODIC DAD	CEL MIIMBEDICI		
– AS	SESSOR'S PAR	CEL NUMBER(S)		
		CEL NUMBER(S)		

Mendocino County

SEP 05 2018

Planning & Building Services

# COASTAL ZONE - SITE AND PROJECT DESCRIPTION QUESTIONNAIRE

The purpose of this questionnaire is to relate information concerning your application to the Planning and Building Services Department and other agencies who will be reviewing your project proposal. Please remember that the clearer picture that your give us of your project and the site, the easier it will be to promptly process your application. Please answer all questions. Those questions which do not pertain to your project, please indicate "Not Applicable" or "N/A".

	1	THE PROJECT	
1.	Describe your project and include seco removal, roads, etc.	ndary improvements such as wells, sep	tic systems, grading, vegetation
45'X45' Fe Install pre- Install (1) C Install (12) Install (12) Install (24) Install (4) S (2) Future Install 15K Trench Po Gravel acc The Wirele	-0" Lattice Tower Antennas, (4) per sector RRUs Surge Suppressors 4' Microwave Dishes W DC Diesel Generator with 54 Gallon Storage Tank wer/Telco (Fiber) to site location less route to site less Facility will serve the community with High Speed B	roadband Wireless Internet, Mobile Phones Services,	and enhance public safety.
2.	If the project is <u>residential</u> , please comp	elete the following: N/A	
	TYPE OF UNIT	NUMBER OF STRUCTURES	SQUARE FEET PER DWELLING UNIT
	Single Family		DWELLING ONT
	Mobile Home		
	Duplex		
	Multifamily		
	If Multifamily, number of dwelling unit	ts per building:	·
3.	If the project is commercial, industrial,	or institutional, complete the following:	
	Total square footage of structures:	2,025'	
	Estimated employees per shift:	0 - N/A	<del></del>
	Estimated shifts per day:	0 - N/A	
	Type of loading facilities proposed:	N/A	
4.	Will the proposed project be phased? If Yes, explain your plans for phasing.	☐ Yes ■ No	

	Are there existing structure If yes, describe below and	s on the property?  Yes identify the use of each structure	No on the plot plan.	
Tente	ed/Canopy parking for bu	uses		
ł				
6.	Will any existing structures	be demolished? Yes	■ No	
0.	Will any existing structures		■ No	
	<b>70</b>	71 .1	1 1 1 1 1 1 1 1 1 1 1 1 1 1 1 1 1 1 1 1	and including the releastion
		escribe the type of development to	o be demolished or remo	ved, including the relocation
	site, if applicable.			
İ				
		1.1.1.0	C	
7.	Project Height. Maximum	1 height of structure 123	fee	ι.
8.	Lot area (within property	lines): 457,380	square feet	acres
9.				
1 2.	Lot Coverage:		A PHY PROPOSE	TOTAL
1		EXISTING	NEW PROPOSEI	
	Building coverage	o square feet	o square fo	eet 0 square feet
7.	Building coverage Paved area	o square feet square feet	$\frac{0}{2,025}$ square for square for $\frac{1}{2}$	$\frac{0}{2,025}$ square feet square feet
)·	Building coverage Paved area Landscaped area	<ul> <li>square feet</li> <li>square feet</li> <li>square feet</li> </ul>	o square for square fo	eet $\frac{0}{2,025}$ square feet eet $\frac{0}{0}$ square feet square feet
	Building coverage Paved area	<ul> <li>square feet</li> <li>square feet</li> <li>square feet</li> </ul>	$\begin{array}{c} 0 & \text{square fo} \\ \hline 2,025 & \text{square fo} \\ \hline 0 & \text{square fo} \\ \hline -2,025 & \text{square fo} \\ \end{array}$	$\begin{array}{cccccccccccccccccccccccccccccccccccc$
	Building coverage Paved area Landscaped area	<ul> <li>square feet</li> <li>square feet</li> <li>square feet</li> </ul>	o square for square fo	$\begin{array}{cccccccccccccccccccccccccccccccccccc$
	Building coverage Paved area Landscaped area Unimproved area	0square feet0square feet0square feet457,380square feet	o square for square fo	$\begin{array}{cccccccccccccccccccccccccccccccccccc$
10.	Building coverage Paved area Landscaped area Unimproved area  Gross floor area: 1,800	0square feet0square feet0square feet457,380square feetsquare feet	$\begin{array}{c c} 0 & \text{square fo} \\ \hline 2,025 & \text{square fo} \\ \hline 0 & \text{square fo} \\ \hline -2,025 & \text{square fo} \\ \hline GRAND TOTAL: \ \ \ \ \ \ \ \ \ \ \ \ \ \ \ \ \ \ \$	$\begin{array}{cccccccccccccccccccccccccccccccccccc$
	Building coverage Paved area Landscaped area Unimproved area	0square feet0square feet0square feet457,380square feetsquare feet	$\begin{array}{c c} 0 & \text{square fo} \\ \hline 2,025 & \text{square fo} \\ \hline 0 & \text{square fo} \\ \hline -2,025 & \text{square fo} \\ \hline GRAND TOTAL: \ \ \ \ \ \ \ \ \ \ \ \ \ \ \ \ \ \ \$	$\begin{array}{cccccccccccccccccccccccccccccccccccc$
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10.	Building coverage Paved area Landscaped area Unimproved area  Gross floor area: 1,800 Parking will be provided a	0       square feet         0       square feet         457,380       square feet         square feet         square feet         square feet         Existing         Existing	o square for square fo	eet 0 square feet eet 2,025 square feet eet 0 square feet eet 455,355 square feet Should equal gross area of parcel) cking and accessory buildings).
10.	Building coverage Paved area Landscaped area Unimproved area  Gross floor area: 1,800 Parking will be provided a Number of Spaces  Number of covered space	square feet  o square feet	o square for square fo	eet 0 square feet eet 2,025 square feet eet 0 square feet eet 455,355 square feet 457,380 square feet Should equal gross area of parcel) rking and accessory buildings).  Total
10.	Building coverage Paved area Landscaped area Unimproved area  Gross floor area: 1,800 Parking will be provided a Number of Spaces Number of covered space Number of uncovered space	square feet  o square feet	o square for square fo	eet 0 square feet eet 2,025 square feet eet 0 square feet eet 455,355 square feet  457,380 square feet Should equal gross area of parcel) cking and accessory buildings).  Total
10.	Building coverage Paved area Landscaped area Unimproved area  Gross floor area: 1,800 Parking will be provided a Number of Spaces  Number of covered space	square feet  o square feet	o square for square fo	eet 0 square feet eet 2,025 square feet eet 0 square feet eet 455,355 square feet 457,380 square feet Should equal gross area of parcel) rking and accessory buildings).  Total

12.	Utilities will be supplied to the site as follows:
	A. Electricity  Utility Company (service exists to the parcel).  Utility Company (requires extension of services to site: 342 feet miles  On Site generation, Specify: 15KW DC Diesel Generator for Backup Power ONLY  None
	B. Gas  Utility Company/Tank  On Site generation, Specify:  None
	C. Telephone: Yes No
	Will there by any exterior lighting?  Yes  No If yes, describe below and identify the location of all exterior lighting on the plot plan and building plans.  ielded Down Tilt Lights with Motion Sensor and Auto Shutoff Timer, located on the Walk-In oment Cabinet.
14.	What will be the method of sewage disposal? N/A
	Community sewage system, specify supplier  Septic Tank Other, specify
15.	What will be the domestic water source? N/A
	Community water system, specify supplier  Well Spring Other, specify
16.	Is any grading or road construction planned? Yes No If yes, grading and drainage plans may be required. Also, describe the terrain to be traversed (e.g., steep, moderate slope, flat, etc.).  Currently the lot is relatively flat. Site will be graded to ensure flatness is established for the site.
	For grading and road construction, complete the following:
	A. Amount of cut:  B. Amount of fill:  C. Maximum height of fill slope:  D. Maximum height of cut slope:  E. Amount of import or export:  C. Location of borrow or disposal site:  Spoils = 43 CU Yards for tower footings, Spoils will be evenly spread on site  in a manner as not to disrupt existing flow patterns.

17.	Will vegetation be removed on areas other than the building sites and roads?  Yes No If yes, explain:
18.	Does the project involve sand removal, mining or gravel extraction?  Yes If yes, detailed extraction, reclamation and monitoring may be required.
19.	Will the proposed development convert land currently or previously used for agriculture to another use? Yes No  If yes, how many acres will be converted? acres (An agricultural economic feasibility study may be required.)
20.	Will the development provide public or private recreational opportunities? ☐ Yes ■ No If yes, explain:
21.	Is the proposed development visible from:  A. State Highway 1 or other scenic route?  B. Park, beach or recreation area?  Site is not visible from Highway 1 or other scenic routes, or, Parks, Beaches, or Recreational Areas.
1	Will the project involve the use or disposal of potentially hazardous materials such as toxic substances, flammables, or explosives? ■ Yes □ No If yes, explain: allons of Diesel fuel for the 15KW DC Diesel Generator. Diesel is stored in a belly tank under rator. No hazardous materials will be disposed.
23.	Does the development involve diking, filling, dredging or placing structures in open coastal waters, wetlands, estuaries or lakes?  A. Diking
	Location of dredged material disposal site:  Has a U.S. Army Corps of Engineers permit been applied for?   No

If you need additional room to answer any question, attach additional sheets.

#### CERTIFICATION AND SITE VIEW AUTHORIZATION

- I hereby certify that I have read this completed application and that, to the best of my knowledge, the information in this application, and all attached appendices and exhibits, is complete and correct. I understand that the failure to provide any requested information or any misstatements submitted in support of the application shall be grounds for either refusing to accept this application, for denying the permit, for suspending or revoking a permit issued on the basis of such misrepresentations, or for seeking of such further relief as may seem proper to the County.
- 2. I hereby grant permission for County Planning and Building Services staff and hearing bodies to enter upon and site view the premises for which this application is made in order to obtain information necessary for the preparation of required reports and render its decision.

John Jared Kearsley 8/28/18
Owner/Authorized Agent Date

NOTE: IF SIGNED BY AGENT, OWNER MUST SIGN BELOW.

#### AUTHORIZATION OF AGENT

I hereby authorize Jared Kearsley with Epic Wireless Group to act as m representative and to bind me in all matters concerning this application.

Owner Date

#### MAIL DIRECTION

To facilitate proper handling of this application, please indicate the names and mailing addresses of individuals to whom you wish correspondence and/or staff reports mailed if different from those identified on Page One of the application form.

Name	Name	Name	
Mailing Address	Mailing Address	Mailing Address	

### COASTAL ZONE DEVELOPMENT

COMPLETE FOR PROJECTS LOCATED IN THE COASTAL ZONE ONLY

List all property owners within 300 feet, and occupants within 100 feet along with the corresponding Assessor's Parcel Number for each owner/occupant. **This form must be typed.** 

AP# 000-000-00 LASTNAME, FIRSTNAME STREET ADDRESS CITY, STATE ZIP	AP# 145-092-02 SANCHEZ, ROBERTO & THERESA PO BOX 871 POINT ARENA, CA 95468	AP# 145-092-03 SPILLE, WLATER PO BOX 1283 GUALALA, CA 95445
AP# 145-092-04	AP# 145-092-19	AP# 145-092-05
PACHECO, PHYLLIS	THE BOWER LIMITED PARTNERSHIP	COOK, VERNON
PO BOX 1283	PO BOX 1,000	PO BOX 59
GUALALA, CA 95445	GUALALA, CA 95445	GUALALA, CA 95445
AP# 145-092-06	AP# 145-092-07	AP# 145-092-08
DUNCAN, MARK AND KELLY	WATERS, STEPHEN	SANCHEZ, THOMAS AND PATRICIA
39321 OLD STAGE ROAD	39341 OLD STAGE ROAD	39361 OLD STAGE ROAD
GUALALA, CA 95445	GUALALA, CA 95445	GUALALA, CA 95445
AP# 145-092-09	AP# 145-092-10	AP# 145-092-11
PIERRE, MICHELE	SORENSEN, ANTHONI	BELLONI, NATALINA
1016 HAMPSHIRE LANE	PO BOX 612	45 BUENA VISTA AVE
WINDSOR, CA 95492	GUALALA, CA 95445	CORTE MADERA, CA 94925
AP# 145-091-21	AP# 145-110-02	AP# 145-110-03
THE BOWER LIMITED PARTNERSHIP	GUALALA REDWOOD TIMBER LLC	THE BOWER LIMITED PARTNERSHIP
PO BOX 1,000	PO BOX 1300	PO BOX 1,000
GUALALA, CA 95445	MORGAN HILL, CA 95038	GUALALA, CA 95445
AP# 145-110-03	AP# 145-091-20	AP# 145-091-09
THE BOWER LIMITED PARTNERSHIP	THE BOWER LIMITED PARTNERSHIP	DIMAIO, RICHARD
PO BOX 1,000	PO BOX 1,000	PO BOX 42
GUALALA, CA 95445	GUALALA, CA 95445	GUALALA, CA 95445
AP# 145-091-08	AP# 145-091-07	AP# 145-091-11
JUNKER, MAXINE	PG&E	MALINASKY, JEAN
PO BOX 144	39200 OLD STAGE ROAD	3 PERALTA CT.
GUALALA, CA 95445	GUALALA, CA 95445	MORAGA, CA 94556
AP# 145-091-11	AP# 145-091-12	AP# 145-091-12
OCCUPANT	ANGELY, HIDALGO	OCCUPANT
3 PERALTA CT.	PO BOX 31	39320 OLD STAGE RD.
MORAGA, CA 94556	ANNAPOLIS, CA 95412	GUALALA, CA 95445
AP# 145-091-13	AP# 145-091-14	AP# 145-091-14
LESTER, JAMES	SANCHEZ, JANET	OCCUPANT
PO BOX 384	PO BOX 871	39350 OLD STAGE RD.
GUALALA, CA 95445	POINT ARENA, CA 95468	GUALALA, CA 95445

#### COASTAL ZONE DEVELOPMENT

COMPLETE FOR PROJECTS LOCATED IN THE COASTAL ZONE ONLY

List all property owners within 300 feet, and occupants within 100 feet along with the corresponding Assessor's Parcel Number for each owner/occupant. **This form must be typed.** 

AP# 000-000-00 LASTNAME, FIRSTNAME STREET ADDRESS CITY, STATE ZIP	AP# 145-091-15 RENEY, GIORDANI 1629 CENTER RD. NOVATO, CA 94947	AP# 145-091-15 OCCUPANT 39360 OLD STAGE RD. GUALALA, CA 95445
AP# 145-091-16 WASHBURN, EMMA 39380 OLD STAGE RD. GUALALA, CA 95445	AP# 145-091-17 MCDONALD, ALEXANDRA PO BOX 504 SEBASTOPOL, CA 95473	AP# 145-091-18 ALVAREZ, DIANA 1901 PLOVER AVE. FORT PIERCE, FL 34949
AP# 145-093-01 SUNDSTROM, TREVOR PO BOX 1191 GUALALA, CA 95445	AP# 145-093-28 ONEIL, MICHAEL 25227 ARCANE AVE VENETA, OR 97487	

#### COMPLETE FOR PROJECTS LOCATED WITHIN THE COASTAL ZONE ONLY

#### DECLARATION OF POSTING

At the time the application is submitted for filing, the applicant must **Post**, at a conspicuous place, easily read by the public and as close as possible to the site of the proposed development, notice that an application for the proposed development has been submitted. Such notice shall contain a general description of the nature of the proposed development and shall be on the standard form provided in the application packet. If the applicant fails to post the completed notice form and sign the **Declaration of Posting**, the Department of Planning and Building Services cannot process the application.

completed notice form and sign the Declaration of Posting, the Department of Planning and Building Services cannot process the application. As Proof of Posting, please sign and date this Declaration of Posting form when the site is posted; it serves as proof of posting. It should be returned to the Department of Planning and Building Services with the application. Pursuant to the requirements of Section 20.532.025(H) of the Mendocino County Code, I hereby certify that on (date of posting), I or my authorized representative posted the "NOTICE OF PENDING PERMIT" for application to obtain a Coastal Development Permit for the development of: Unmanned AT&T Wireless Telecommunications Facility: 123 foot tall Lattice Tower for High Speed Broadband Wireless Internet and AT&T Mobile Services. Pre-manufactured walk in equipment cabinet and associated interior equipment. 15KW DC Diesel Generator. All within a 45'X45' Fenced Area. (Description of development) Located at: 39290 Old Stage Road, Gualala, CA 95445 AP# 145-091-22-00 (Address of development and Assessor's Parcel Number) The public notice was posted at: On a utility pole next to a fire hydrant at the entrance to the property. Corner of Old Stage Road and property entrance. (A conspicuous place, easily seen by the public and as close as possible to the site of proposed development)

Owner/Authorized Representative

8/28/18

Date

(A copy of the notice which was posted shall be attached to this form).

**NOTE:** YOUR APPLICATION CANNOT BE PROCESSED UNTIL THIS "DECLARATION OF POSTING" IS SIGNED AND RETURNED TO PLANNING AND BUILDING SERVICES.

#### COMPLETE FOR PROJECTS LOCATED WITHIN THE COASTAL ZONE ONLY

#### DECLARATION OF POSTING

At the time the application is submitted for filing, the applicant must **Post**, at a conspicuous place, easily read by the public and as close as possible to the site of the proposed development, notice that an application for the proposed development has been submitted. Such notice shall contain a general description of the nature of the proposed development and shall be on the standard form provided in the application packet. If the applicant fails to post the completed notice form and sign the **Declaration of Posting**, the Department of Planning and Building Services cannot process the application.

completed notice form and sign the Declaration of Posting, the Department of Planning and Building Services cannot As Proof of Posting, please sign and date this Declaration of Posting form when the site is posted; it serves as proof of posting. It should be returned to the Department of Planning and Building Services with the application. Pursuant to the requirements of Section 20.532.025(H) of the Mendocino County Code, I hereby certify that on (date of posting), I or my authorized representative posted the "NOTICE OF PENDING PERMIT" for application to obtain a Coastal Development Permit for the development of: Unmanned AT&T Wireless Telecommunications Facility: 123 foot tall Lattice Tower for High Speed Broadband Wireless Internet and AT&T Mobile Services. Pre-manufactured walk in equipment cabinet and associated interior equipment. 15KW DC Diesel Generator. All within a 45'X45' Fenced Area. (Description of development) Located at: 39290 Old Stage Road, Gualala, CA 95445 AP# 145-091-22-00 (Address of development and Assessor's Parcel Number) The public notice was posted at: On a utility pole next to a fire hydrant at the entrance to the property. Corner of Old Stage Road and property entrance. (A conspicuous place, easily seen by the public and as close as possible to the site of proposed development)

Owner/Authorized Representative

8/29/18

Date

(A copy of the notice which was posted shall be attached to this form).

**NOTE:** YOUR APPLICATION CANNOT BE PROCESSED UNTIL THIS "DECLARATION OF POSTING" IS SIGNED AND RETURNED TO PLANNING AND BUILDING SERVICES.

COMPLETE FOR PROJECTS LOCATED WITHIN THE COASTAL ZONE ONLY

## NOTICE OF PENDING PERMIT

A COASTAL PERMIT APPLICATION FOR DEVELOPMENT ON THIS SITE IS PENDING BEFORE THE COUNTY OF MENDOCINO:

PROPOSED DEVELOPMENT: Unmanned AT&T Wireless Telecommunications Facility:
123 foot tall Lattice Tower for High Speed Broadband Wireless Internet and AT&T Mobile Services.
Pre-manufactured walk in equipment cabinet and associated interior equipment.
15KW DC Diesel Generator. All within a 45'X45' Fenced Area.
LOCATION: 39290 Old Stage Road, Gualala, CA 95445
APPLICANT: AT&T Mobility
ASSESSOR'S PARCEL NUMBER(S): 145-091-22-00
DATE NOTICE POSTED: 8/29/18

FOR FURTHER INFORMATION, PLEASE TELEPHONE OR WRITE TO:

COUNTY OF MENDOCINO PLANNING & BUILDING SERVICES 860 NORTH BUSH STREET UKIAH, CA 95482 707-234-6650





SITE NUMBER: CCL05838

SITE NAME: GUALALA

39290 OLD STAGE ROAD GUALALA, CA 95445

**USID: 205189** FA: 14442803

SHALL VERIFY ALL PLANS AND EXISTING DIMENSIONS AND CONDITIONS ON THE


JOBSITE AND SHALL IMMEDIATELY NOTIFY THE ARCHITECT/ENGINEER IN WRITING OF

ANY DISCREPANCIES BEFORE PROCEEDING WITH THE WORK OR MATERIAL ORDERS

OR BE RESPONSIBLE FOR THE SAME.

**JURISDICTION: MENDOCINO COUNTY** 

# SITE TYPE: LATTICE TOWER/WALK IN EQUIPMENT CABINET

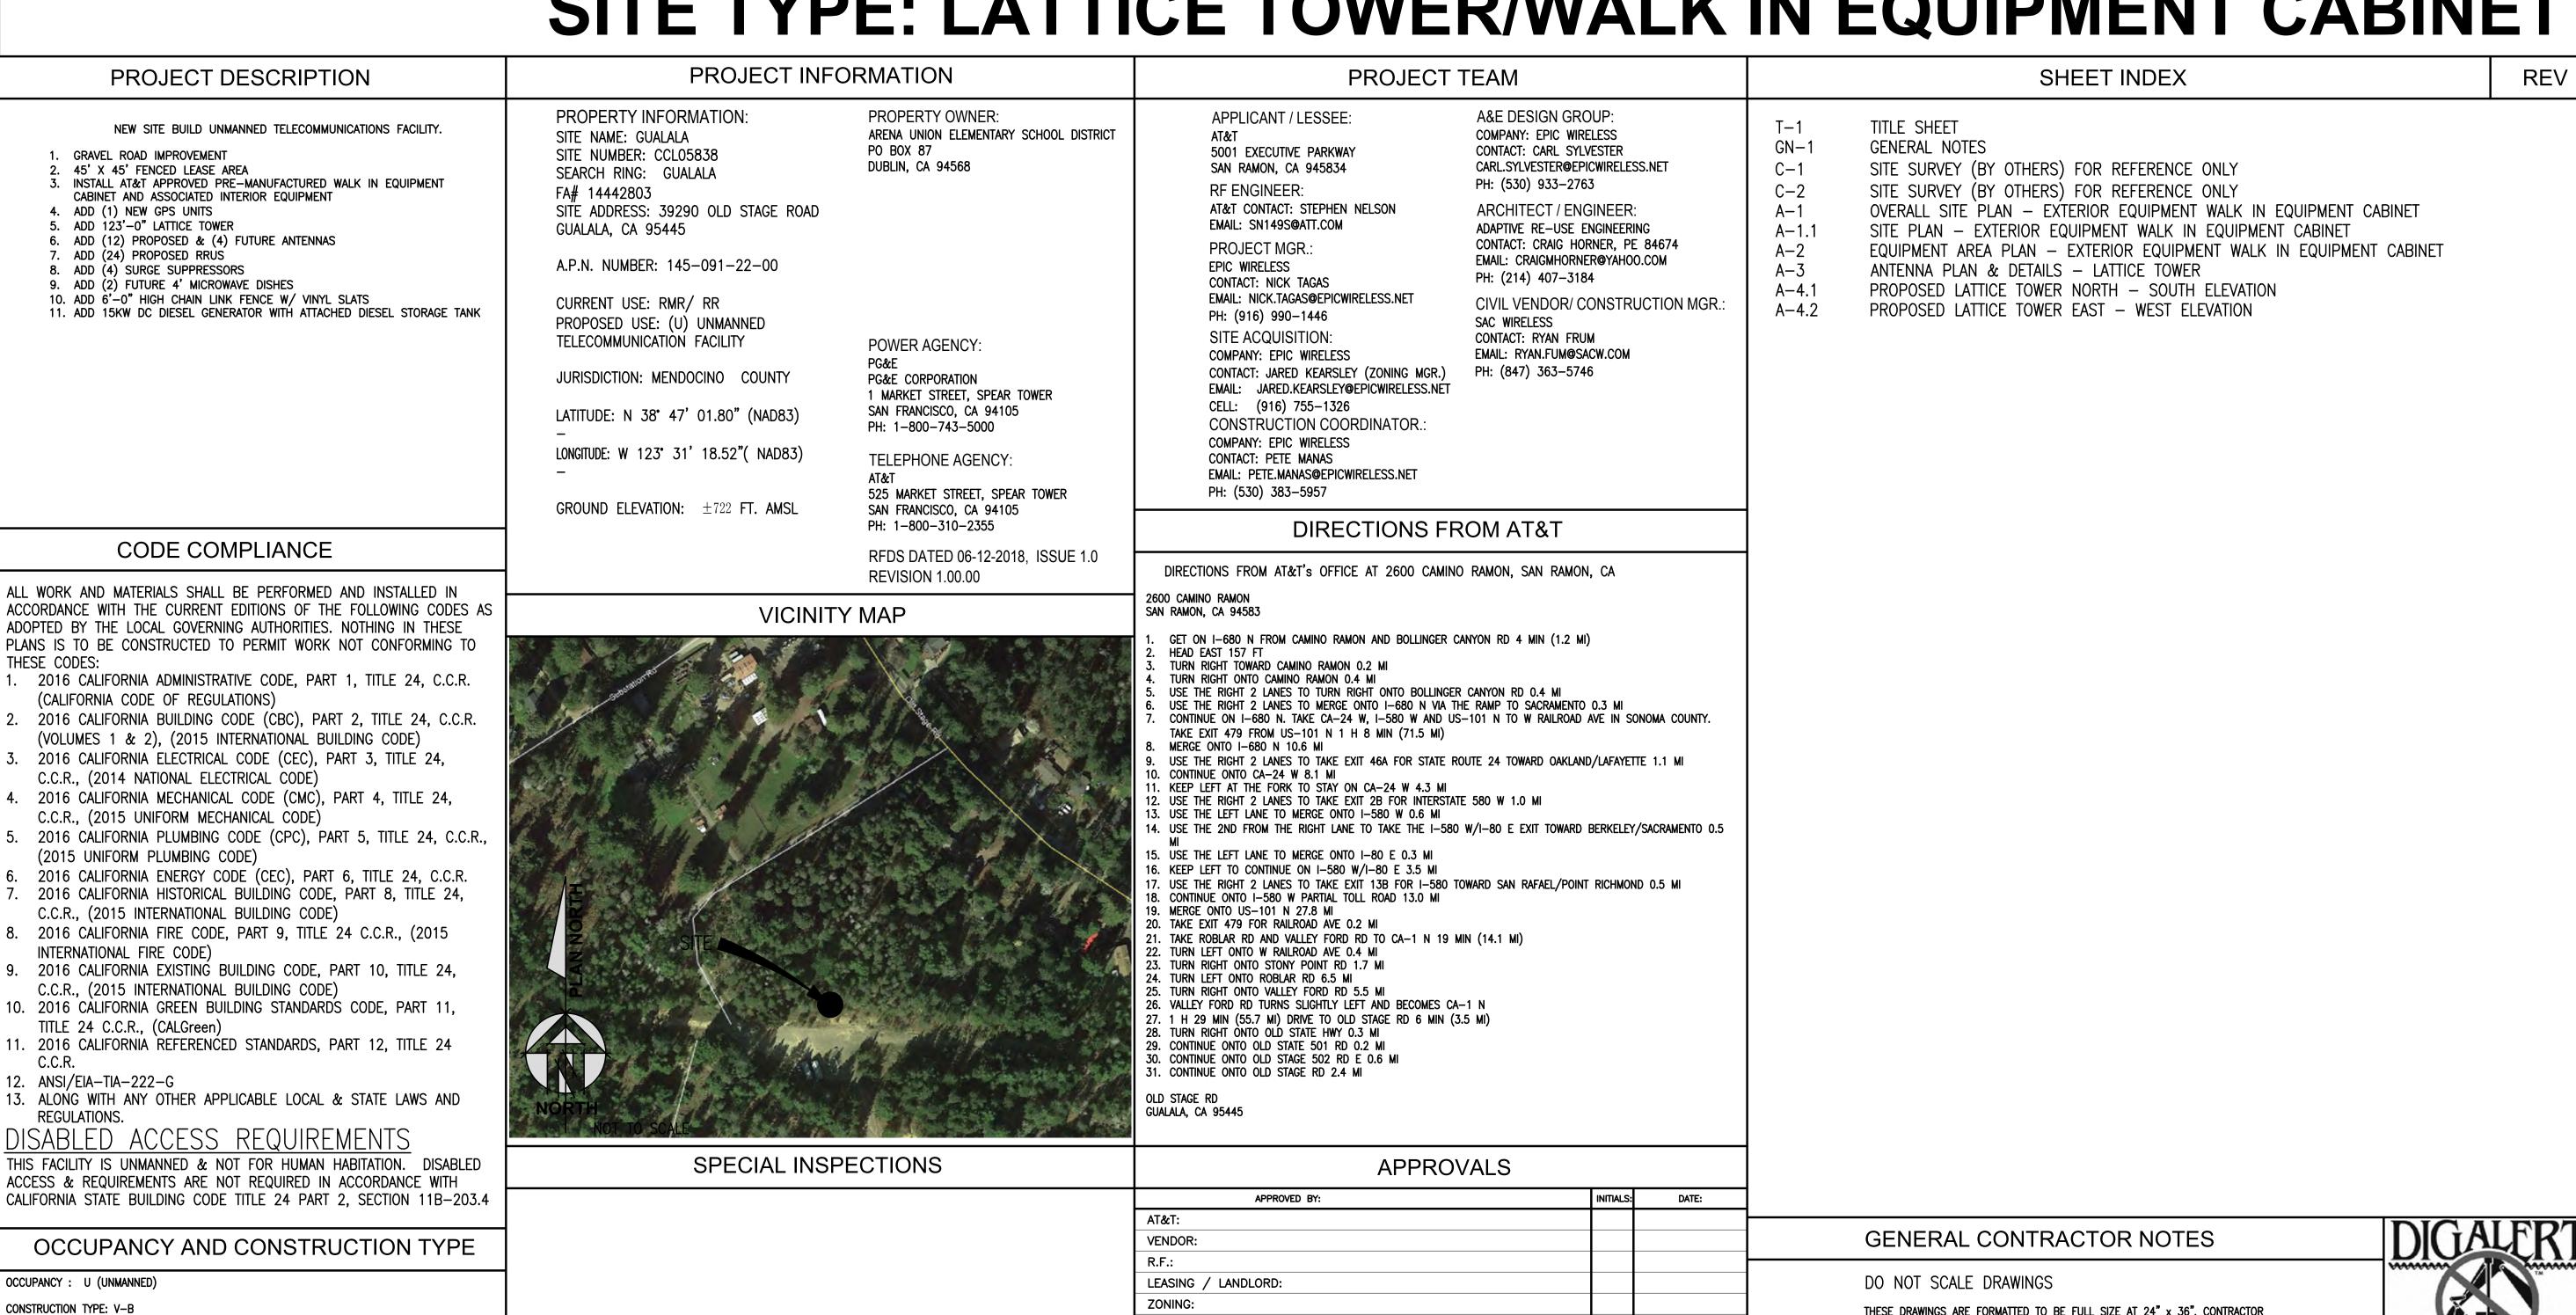

**CONSTRUCTION:** 

PG&E:

POWER / TELCO:

GUALALA

39290 OLD STAGE ROAD GUALALA, CA 95445






San Ramon, California 94583



AT&T SITE NO:	CCL05838
PROJECT NO:	14442803
DRAWN BY:	CES
CHECKED BY:	CES

0	06/26/18	ZD 90%
0	07/11/18	ZD 100%
REV	DATE	DESCRIPTION

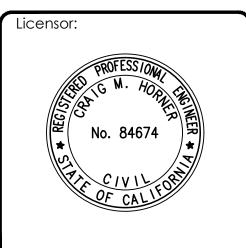

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Engineer:

## **ADAPTIVE RE-USE ENGINEERING**

Craig Horner, PE 84674 214-407-3184 3112 LEATHA WAY SACRAMENTO, CA 95821 craigmhorner@yahoo.com

TITLE SHEET

SHEET NUMBER:

-1

## **GENERAL CONSTRUCTION NOTES:**

- PLANS ARE INTENDED TO BE DIAGRAMMATIC OUTLINE ONLY, UNLESS NOTED OTHERWISE. THE WORK SHALL INCLUDE FURNISHING MATERIALS, EQUIPMENT, APPURTENANCES AND LABOR NECESSARY TO COMPLETE ALL INSTALLATIONS AS INDICATED ON THE DRAWINGS.
- THE CONTRACTOR SHALL OBTAIN, IN WRITING, AUTHORIZATION TO PROCEED BEFORE STARTING WORK ON ANY ITEM NOT CLEARLY DEFINED OR IDENTIFIED BY THE CONTRACT DOCUMENTS.
- CONTRACTOR SHALL CONTACT USA (UNDERGROUND SERVICE ALERT) AT (800) 227-2600, FOR UTILITY LOCATIONS, 48 HOURS BEFORE PROCEEDING WITH ANY EXCAVATION, SITE WORK OR CONSTRUCTION.
- THE CONTRACTOR SHALL INSTALL ALL EQUIPMENT AND MATERIALS IN ACCORDANCE WITH MANUFACTURER'S RECOMMENDATIONS UNLESS SPECIFICALLY INDICATED OTHERWISE, OR WHERE LOCAL CODES OR REGULATIONS TAKE PRECEDENCE.
- ALL CONSTRUCTION SHALL BE IN ACCORDANCE WITH THE CBC/UBC'S REQUIREMENTS REGARDING EARTHQUAKE RESISTANCE, FOR, BUT NOT LIMITED TO, PIPING, LIGHT FIXTURES, CEILING GRID, INTERIOR PARTITIONS, AND MECHANICAL EQUIPMENT. ALL WORK MUST COMPLY WITH LOCAL EARTHQUAKE CODES AND REGULATIONS.
- REPRESENTATIONS OF TRUE NORTH, OTHER THAN THOSE FOUND ON THE PLOT OF SURVEY DRAWINGS, SHALL NOT BE USED TO IDENTIFY OR ESTABLISH BEARING OF TRUE NORTH AT THE SITE. THE CONTRACTOR SHALL RELY SOLELY ON THE PLOT OF SURVEY DRAWING AND ANY SURVEYOR'S MARKINGS AT THE SITE FOR THE ESTABLISHMENT OF TRUE NORTH, AND SHALL NOTIFY THE ARCHITECT / ENGINEER PRIOR TO PROCEEDING WITH THE WORK IF ANY DISCREPANCY IS FOUND BETWEEN THE VARIOUS ELEMENTS OF THE WORKING DRAWINGS AND THE TRUE NORTH ORIENTATION AS DEPICTED ON THE CIVIL SURVEY. THE CONTRACTOR SHALL ASSUME SOLE LIABILITY FOR ANY FAILURE TO NOTIFY THE ARCHITECT / ENGINEER.
- 7. THE BUILDING DEPARTMENT ISSUING THE PERMITS SHALL BE NOTIFIED AT LEAST TWO WORKING DAYS PRIOR TO THE COMMENCEMENT OF WORK, OR AS OTHERWISE STIPULATED BY THE CODE ENFORCEMENT OFFICIAL HAVING JURISDICTION.
- 8. DO NOT EXCAVATE OR DISTURB BEYOND THE PROPERTY LINES OR LEASE LINES, UNLESS OTHERWISE NOTED.
- 9. ALL EXISTING UTILITIES, FACILITIES, CONDITIONS, AND THEIR DIMENSIONS SHOWN ON THE PLAN HAVE BEEN PLOTTED FROM AVAILABLE RECORDS. THE ARCHITECT / ENGINEER AND THE OWNER ASSUME NO RESPONSIBILITY WHATSOEVER AS TO THE SUFFICIENCY OR THE ACCURACY OF THE INFORMATION SHOWN ON THE PLANS, OR THE MANNER OF THEIR REMOVAL OR ADJUSTMENT. CONTRACTORS SHALL BE RESPONSIBLE FOR DETERMINING EXACT LOCATION OF ALL EXISTING UTILITIES AND FACILITIES PRIOR TO START OF CONSTRUCTION. CONTRACTORS SHALL ALSO OBTAIN FROM EACH UTILITY COMPANY DETAILED INFORMATION RELATIVE TO WORKING SCHEDULES AND METHODS OF REMOVING OR ADJUSTING EXISTING UTILITIES.
- 10. CONTRACTOR SHALL VERIFY ALL EXISTING UTILITIES, BOTH HORIZONTAL AND VERTICALLY, PRIOR TO THE START OF CONSTRUCTION. ANY DISCREPANCIES OR DOUBTS AS TO THE INTERPRETATION OF PLANS SHOULD BE IMMEDIATELY REPORTED TO THE ARCHITECT / ENGINEER FOR RESOLUTION AND INSTRUCTION, AND NO FURTHER WORK SHALL BE PERFORMED UNTIL THE DISCREPANCY IS CHECKED AND CORRECTED BY THE ARCHITECT / ENGINEER. FAILURE TO SECURE SUCH INSTRUCTION MEANS CONTRACTOR WILL HAVE WORKED AT HIS/HER OWN RISK AND
- 11. ALL NEW AND EXISTING UTILITY STRUCTURES ON SITE AND IN AREAS TO BE DISTURBED BY CONSTRUCTION SHALL BE ADJUSTED TO FINISH ELEVATIONS PRIOR TO FINAL INSPECTION OF WORK.
- 12. ANY DRAIN AND/OR FIELD TILE ENCOUNTERED / DISTURBED DURING CONSTRUCTION SHALL BE RETURNED TO IT'S ORIGINAL CONDITION PRIOR TO COMPLETION OF WORK. SIZE, LOCATION AND TYPE OF ANY UNDERGROUND UTILITIES OR IMPROVEMENTS SHALL BE ACCURATELY NOTED AND PLACED ON "AS-BUILT" DRAWINGS BY GENERAL CONTRACTOR, AND ISSUED TO THE ARCHITECT / ENGINEER AT COMPLETION OF PROJECT.
- 13. ALL TEMPORARY EXCAVATIONS FOR THE INSTALLATION OF FOUNDATIONS, UTILITIES, ETC., SHALL BE PROPERLY LAID BACK OR BRACED IN ACCORDANCE WITH CORRECT OCCUPATIONAL SAFETY AND HEALTH ADMINISTRATION (OSHA) REQUIREMENTS.
- 14. INCLUDE MISC. ITEMS PER AT&T SPECIFICATIONS

## **APPLICABLE CODES, REGULATIONS AND STANDARDS:**

SUBCONTRACTOR'S WORK SHALL COMPLY WITH ALL APPLICABLE NATIONAL, STATE, AND LOCAL CODES AS ADOPTED BY THE LOCAL AUTHORITY HAVING JURISDICTION (AHJ) FOR THE LOCATION.

THE EDITION OF THE AHJ ADOPTED CODES AND STANDARDS IN EFFECT ON THE DATE OF CONTRACT AWARD SHALL GOVERN THE DESIGN.

## SUBCONTRACTOR'S WORK SHALL COMPLY WITH THE LATEST EDITION OF THE FOLLOWING STANDARDS:

- -AMERICAN CONCRETE INSTITUTE (ACI) 318, BUILDING CODE REQUIREMENTS FOR STRUCTURAL CONCRETE
- -AMERICAN INSTITUTE OF STEEL CONSTRUCTION (AISC), MANUAL OF STEEL CONSTRUCTION, ASD, NINTH EDITION
- -TELECOMMUNICATIONS INDUSTRY ASSOCIATION (TIA) 222-G, STRUCTURAL STANDARD FOR STRUCTURAL ANTENNA TOWER AND ANTENNA SUPPORTING STRUCTURES
- -INSTITUTE FOR ELECTRICAL AND ELECTRONICS ENGINEERS (IEEE) 81, GUIDE FOR MEASURING EARTH RESISTIVITY, GROUND IMPEDANCE, AND EARTH SURFACE POTENTIALS OF A GROUND SYSTEM IEEE 1100 (1999) RECOMMENDED PRACTICE FOR POWERING AND GROUNDING OF ELECTRICAL EQUIPMENT.
- -IEEE C62.41, RECOMMENDED PRACTICES ON SURGE VOLTAGES IN LOW VOLTAGE AC POWER CIRCUITS (FOR LOCATION CATEGORY "C3" AND "HIGH SYSTEM EXPOSURE")

TIA 607 COMMERCIAL BUILDING GROUNDING AND BONDING REQUIREMENTS FOR TELECOMMUNICATIONS TELCORDIA GR-63 NETWORK

EQUIPMENT-BUILDING SYSTEM (NEBS): PHYSICAL PROTECTION TELCORDIA GR-347 CENTRAL OFFICE POWER WIRING

TELCORDIA GR-1275 GENERAL INSTALLATION REQUIREMENTS TELCORDIA GR-1503 COAXIAL CABLE CONNECTIONS

ANY AND ALL OTHER LOCAL & STATE LAWS AND REGULATIONS

FOR ANY CONFLICTS BETWEEN SECTIONS OF LISTED CODES AND STANDARDS REGARDING MATERIAL, METHODS OF CONSTRUCTION, OR OTHER REQUIREMENTS, THE MOST RESTRICTIVE SHALL GOVERN. WHERE THERE IS CONFLICT BETWEEN A GENERAL REQUIREMENT AND A SPECIFIC REQUIREMENT, THE SPECIFIC REQUIREMENT SHALL GOVERN.

#### **ABBREVIATIONS** ANCHOR BOLT ICGB. ISOLATED COPPER GROUND BUS ANTENNA CABLE COVER ASSEMBLY ACCA IN. ( ' ADDITIONAL INTERIOR ABOVE FINISHED FLOOR POUND(S) A.F.G. ABOVE FINISHED GRADE LAG BOLTS ALUM. ALUMINUM LINEAR FEET (FOOT) ALTERNATE LONG(ITUDINAL) antenna MASONRY APPRX. APPROXIMATE(LY) MAXIMUM ARCH. ARCHITECT(URAL) MACHINE BOLT AWG. BLDG. AMERICAN WIRE GAUGE MECHANICAL BUILDING MANUFACTURER BLK. BLOCK MINIMUM BLKG. BLOCKING **MISCELLANEOUS** METAL BOUNDARY NAILING NEW BTCW. BARE TINNED COPPER WIRE NUMBER B.O.F. BOTTOM OF FOOTING N.T.Š. NOT TO SCALE B/U BACK-UP CABINET ON CENTER CAB. CABINET OPENING CANT. CANTILEVER(ED) PROPOSED C.I.P. CAST IN PLACE PRECAST CONCRETE CLG. CLR. CEILING PCS PERSONAL COMMUNICATION SERVICES CLEAR PLY. PLYWOOD COL. COLUMN POWER PROTECTION CABINET CONC. CONCRETE PRIMARY RADIO CABINET CONN. CONNECTION(OR) POUNDS PER SQUARE FOOT CONST CONSTRUCTION POUNDS PER SQUARE INCH CONT. CONTINUOUS P.T. PRESSURE TREATED PENNY (NAILS) POWER (CABINET) DOUBLE QTY. QUANTITY DEPT. DEPARTMENT RAD.(R) RADIUS DOUGLAS FIR REFERENCE DIAMETER REINF. REINFORCEMENT(ING) DIAGONAL REQUIRED DIMENSION RGS. RIGID GALVANIZED STEEL DWG. DRAWING(S) SCH. SHT. SCHEDULE DOWEL(S) EACH SIM. ELEVATION SPECIFICATIONS ELECTRICAL ELEV. ELEVATOR STAINLESS STEEL EMT. ELECTRICAL METALLIC TUBING STD. STL. **STANDARD** E.N. EDGE NAIL ENG. ENGINEER STRUC. STRUCTURAL **EQUAL** TEMP. **TEMPORARY EXPANSION** THICK(NESS) EXST.(E) **EXISTING** T.N. TOE NAIL **EXTERIOR** T.O.A. TOP OF ANTENNA FUTURE T.O.C. TOP OF CURB FABRICATION(OR T.O.F. TOP OF FOUNDATION FINISH FLOOR T.O.P. TOP OF PLATE (PARAPET) FINISH GRADE T.O.S. TOP OF STEEL FINISH(ED) T.O.W. TOP OF WALL FLR. FLOOR ` FDN. F.O.C. FOUNDATION UNDER GROUND FACE OF CONCRETE UNDERWRITERS LABORATORY F.O.M. FACE OF MASONRY UNLESS NOTED OTHERWISE F.0.S. FACE OF STUD VERIFY IN FIELD F.O.W. FACE OF WALL WIDE (WIDTH) F.S. FINISH SURFACE FT.( ' FOOT (FEET) WOOD WEATHERPROOF GROWTH (CABINET) WEIGHT GAUGE CENTERLINE GALVANIZE(D) PLATE, PROPERTY LINE GROUND FAULT CIRCUIT INTERRUPTER GLB. (GLU-LAM) GLUE LAMINATED BEAM GLOBAL POSITIONING SYSTEM GRND. GROUND HDR. HEADER HANGER SYMBOLS LEGEND GROUT OR PLASTER (P) ANTENNA (P) RRU BLDG. SECTION (E) BRICK ROAD SECTION (P) DC SURGE SUPPRESSION (E) MASONRY (F) ANTENNA WALL SECTION CONCRETE (F) RRU EARTH (E) EQUIPMENT GRAVEL DETAIL A-500 PLYWOOD SAND ELEVATION PLYWOOD (E) STEEL (001) DOOR SYMBOL MATCH LINE GROUND CONDUCTOR WINDOW SYMBOL OVERHEAD SERVICE CONDUCTORS TILT-UP PANEL MARK —— TELCO —— TELEPHONE CONDUIT PROPERTY LINE ------ POWER -----POWER CONDUIT ----- CENTERLINE POWER/TELCO CONDUIT ———— CDAX ———— ELEVATION DATUM COAXIAL CABLE ——— HYBRID ——— HYBRID CABLE GRID/COLUMN LINE CHAIN LINK FENCE KEYNOTE, DIMENSION WOOD FENCE KEYNOTE, EXISTING FLOW LINE CONSTRUCTION ITEM NEW FLOW LINE WALL TYPE MARK FIBER ROLL SILT FENCE OFFICE ROOM NAME ROOM NUMBER 101

Issued For:

GUALALA

39290 OLD STAGE ROAD

GUALALA, CA 95445

PREPARED FOR



2600 Camino Ramon, 4W850 N San Ramon, California 94583



1	AT&T SITE NO:	CCL05838
	PROJECT NO:	14442803
	DRAWN BY:	CES
4	CHECKED BY:	CES

0	06/26/18	ZD 90%
0	07/11/18	ZD 100%
REV	DATE	DESCRIPTION
•	1	

Licensor:



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Engineer:

## **ADAPTIVE RE-USE ENGINEERING**

Craig Horner, PE 84674 214-407-3184 3112 LEATHA WAY SACRAMENTO, CA 95821 craigmhorner@yahoo.com

SHEET TITLE:

**GENERAL NOTES** 

#### Lease Area Description

All that certain lease area being a portion of that certain 10.54 acre parcel as is shown on that certain Record of Survey filed for record in Maps at Drawer 68, Page 39, Mendocino County Records, located in the County of Mendocino, State of California, and being a portion of Section 22, Township 11 N., Range 15 W., M.D.B.& M, and being more particularly described as follows:

Commencing at a 1/2" pipe with plug labeled LS4873 set for the Southeast terminus of that certain boundary tangent labeled "N 26°51'29" W 103.82'" from which a similar monument bears North 26°51'29" West 103.82 feet; thence from said point of commencement North 50°07'32" East 123.77 feet to the True Point of Beginning; thence from said True Point of Beginning North 80°00'00" East 45.00 feet; thence North 10°00'00" West 45.00 feet; thence South 80°00'00" West 45.00 feet; thence South 10°00'00" East 45.00 feet to the point of beginning.

Together with a non-exclusive easement for access and utility purposes fifteen feet in width the centerline of which is described as follows: beginning at a point which bears 1)South 10°00'00" East 7.50 feet and 2) North 80°00'00" East 35.19 feet from the Southeast corner of the above described lease area and running thence South 80°00'00" West 93.21 feet; thence through a tangent curve to the right having a radius of 57.50 feet for an arc distance of 26.29 feet thence tangent to last curve North 73°47'57" West 96.45 feet; thence through a tangent curve to the left having a radius of 57.50 feet for an arc distance of 11.84 feet; thence tangent to last curve North 85°36'01" West 7.43 feet; thence through a tangent curve to the right having a radius of 57.50 feet for an arc distance of 54.11 feet; thence tangent to last curve North 31°40'48" West 105.39 feet: thence through a tangent curve to the right having a radius of 182.00 feet for an arc distance of 53.98 feet thence tangent to last curve North 14°41'16" West 15.30 feet; thence through a tangent curve to the right having a radius of 112.00 feet for an arc distance of 50.66 feet; thence tangent to last curve North 11°13'44" East 2.01 feet; thence through a tangent curve to the right having a radius of 66.00 feet for an arc distance of 23.00 feet thence tangent to last curve North 31°11'57" East 4.59 feet; thence through a tangent curve to the right having a radius of 100.00 feet for an arc distance of 47.34 feet thence tangent to last curve North 58°19'22" East 66.62 feet; thence North 57°15'03" East 81.48 feet; thence North 58°38'24" East 223.97 feet; thence North 58°10'19" East 118.00 feet; thence North 59°03'08" East 85.56 feet; thence North 57°47'18" East 30 feet more or less to the public right of way more commonly known as Old Stage Road. Including the "Turn-Around" as is generally shown hereon.

THESE DRAWINGS AND/OR THE ACCOMPANYING SPECIFICATION AS INSTRUMENTS OF SERVICE, ARE THE EXCLUSIVE PROPERTY OF GEIL ENGINEERING AND THEIR USE AND PUBLICATION SHALL BE RESTRICTED TO THE ORIGINAL SITE AND CARRIER FOR WHICH THEY ARE PREPARED. REUSE, REPRODUCTION OR PUBLICATION BY ANY METHOD, IN WHOLE OR IN PART, IS PROHIBITED EXCEPT BY WRITTEN PERMISSION FROM GEIL ENGINEERING TITLE TO THESE PLANS AND/OR SPECIFICATIONS SHALL REMAIN WITH GEIL ENGINEERING WITHOUT PREJUDICE AND VISUAL CONTACT WITH THEM SHALL CONSTITUTE PRIMA FACIE EVIDENCE OF ACCEPTANCE OF THESE RESTRICTIONS.

SCALE 1" = 100

DATE OF SURVEY: 05-01-18

SURVEYED BY OR UNDER DIRECTION OF: KENNETH D. GEIL, R.C.E. 14803

LOCATED IN THE COUNTY OF MENDOCINO, STATE OF CALIFORNIA

BEARINGS SHOWN ARE BASED UPON MONUMENTS FOUND AND RECORD INFORMATION. THIS IS NOT A BOUNDARY SURVEY.

ELEVATIONS SHOWN ON THIS PLAN ARE BASED UPON U.S.G.S. N.A.V.D. 88 DATUM. ABOVE MEAN SEA LEVEL.

N.G.V.D. 1929 CORRECTION: SUBTRACT 2.87' FROM ELEVATIONS SHOWN.

CONTOUR INTERVAL: N/A

CONTRACTOR IS RESPONSIBLE TO VERIFY LEASE AREA PRIOR TO CONSTRUCTION.

ASSESSOR'S PARCEL NUMBER: 145-091-22-00

ARENA ELEMENTARY SCHOOL DISTRICT PO BOX 87 DUBLIN, CA 94568

Geil Engineering Engineering \* Surveying \* Planning 1226 High Street

Project No./Name:

Auburn, California 95603-5015 Phone: (530) 885-0426 \* Fax: (530) 823-1309

A.T.& T. Mobility

Project Site Location: 39290 Old Stage Road Gualala, CA 95445

Mendocino County

Date of Observation: 04-30-18

Equipment/Procedure Used to Obtain Coordinates: Trimble Pathfinder Pro XL post processed with Pathfinder Office software.

CCL05838 / GUALALA

Type of Antenna Mount: Proposed Lattice Tower


Coordinates (Tower)


Latitude: N 38° 47' 01.80" (NAD83) N 38° 47' 02.12" (NAD27) Longitude: W 123° 31' 18.52" (NAD83) W 123° 31' 14.48" (NAD27)


ELEVATION of Ground at Structure (NAVD88) 722' AMSL


CERTIFICATION: I, the undersigned, do hereby certify elevation listed above is based on a field survey done under my supervision and that the accuracy of those elevations meet or exceed 1—A Standards as defined in the FAA ASAC Information Sheet 91:003, and that they are true and accurate to the best of my knowledge and belief.

Kenneth D. Geil California RCE 14803

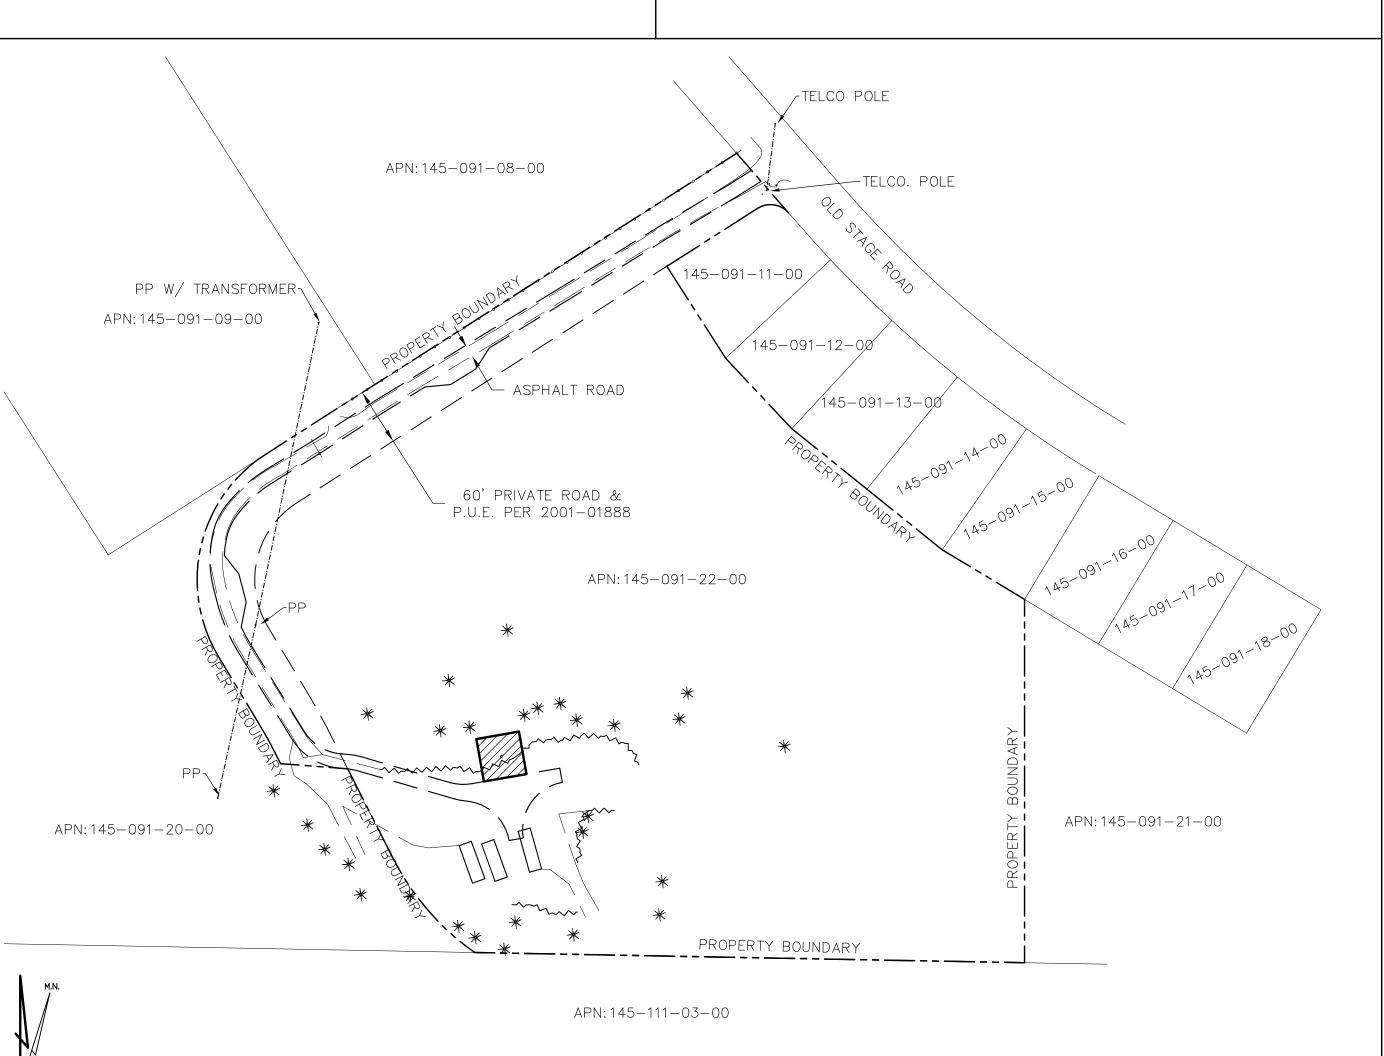

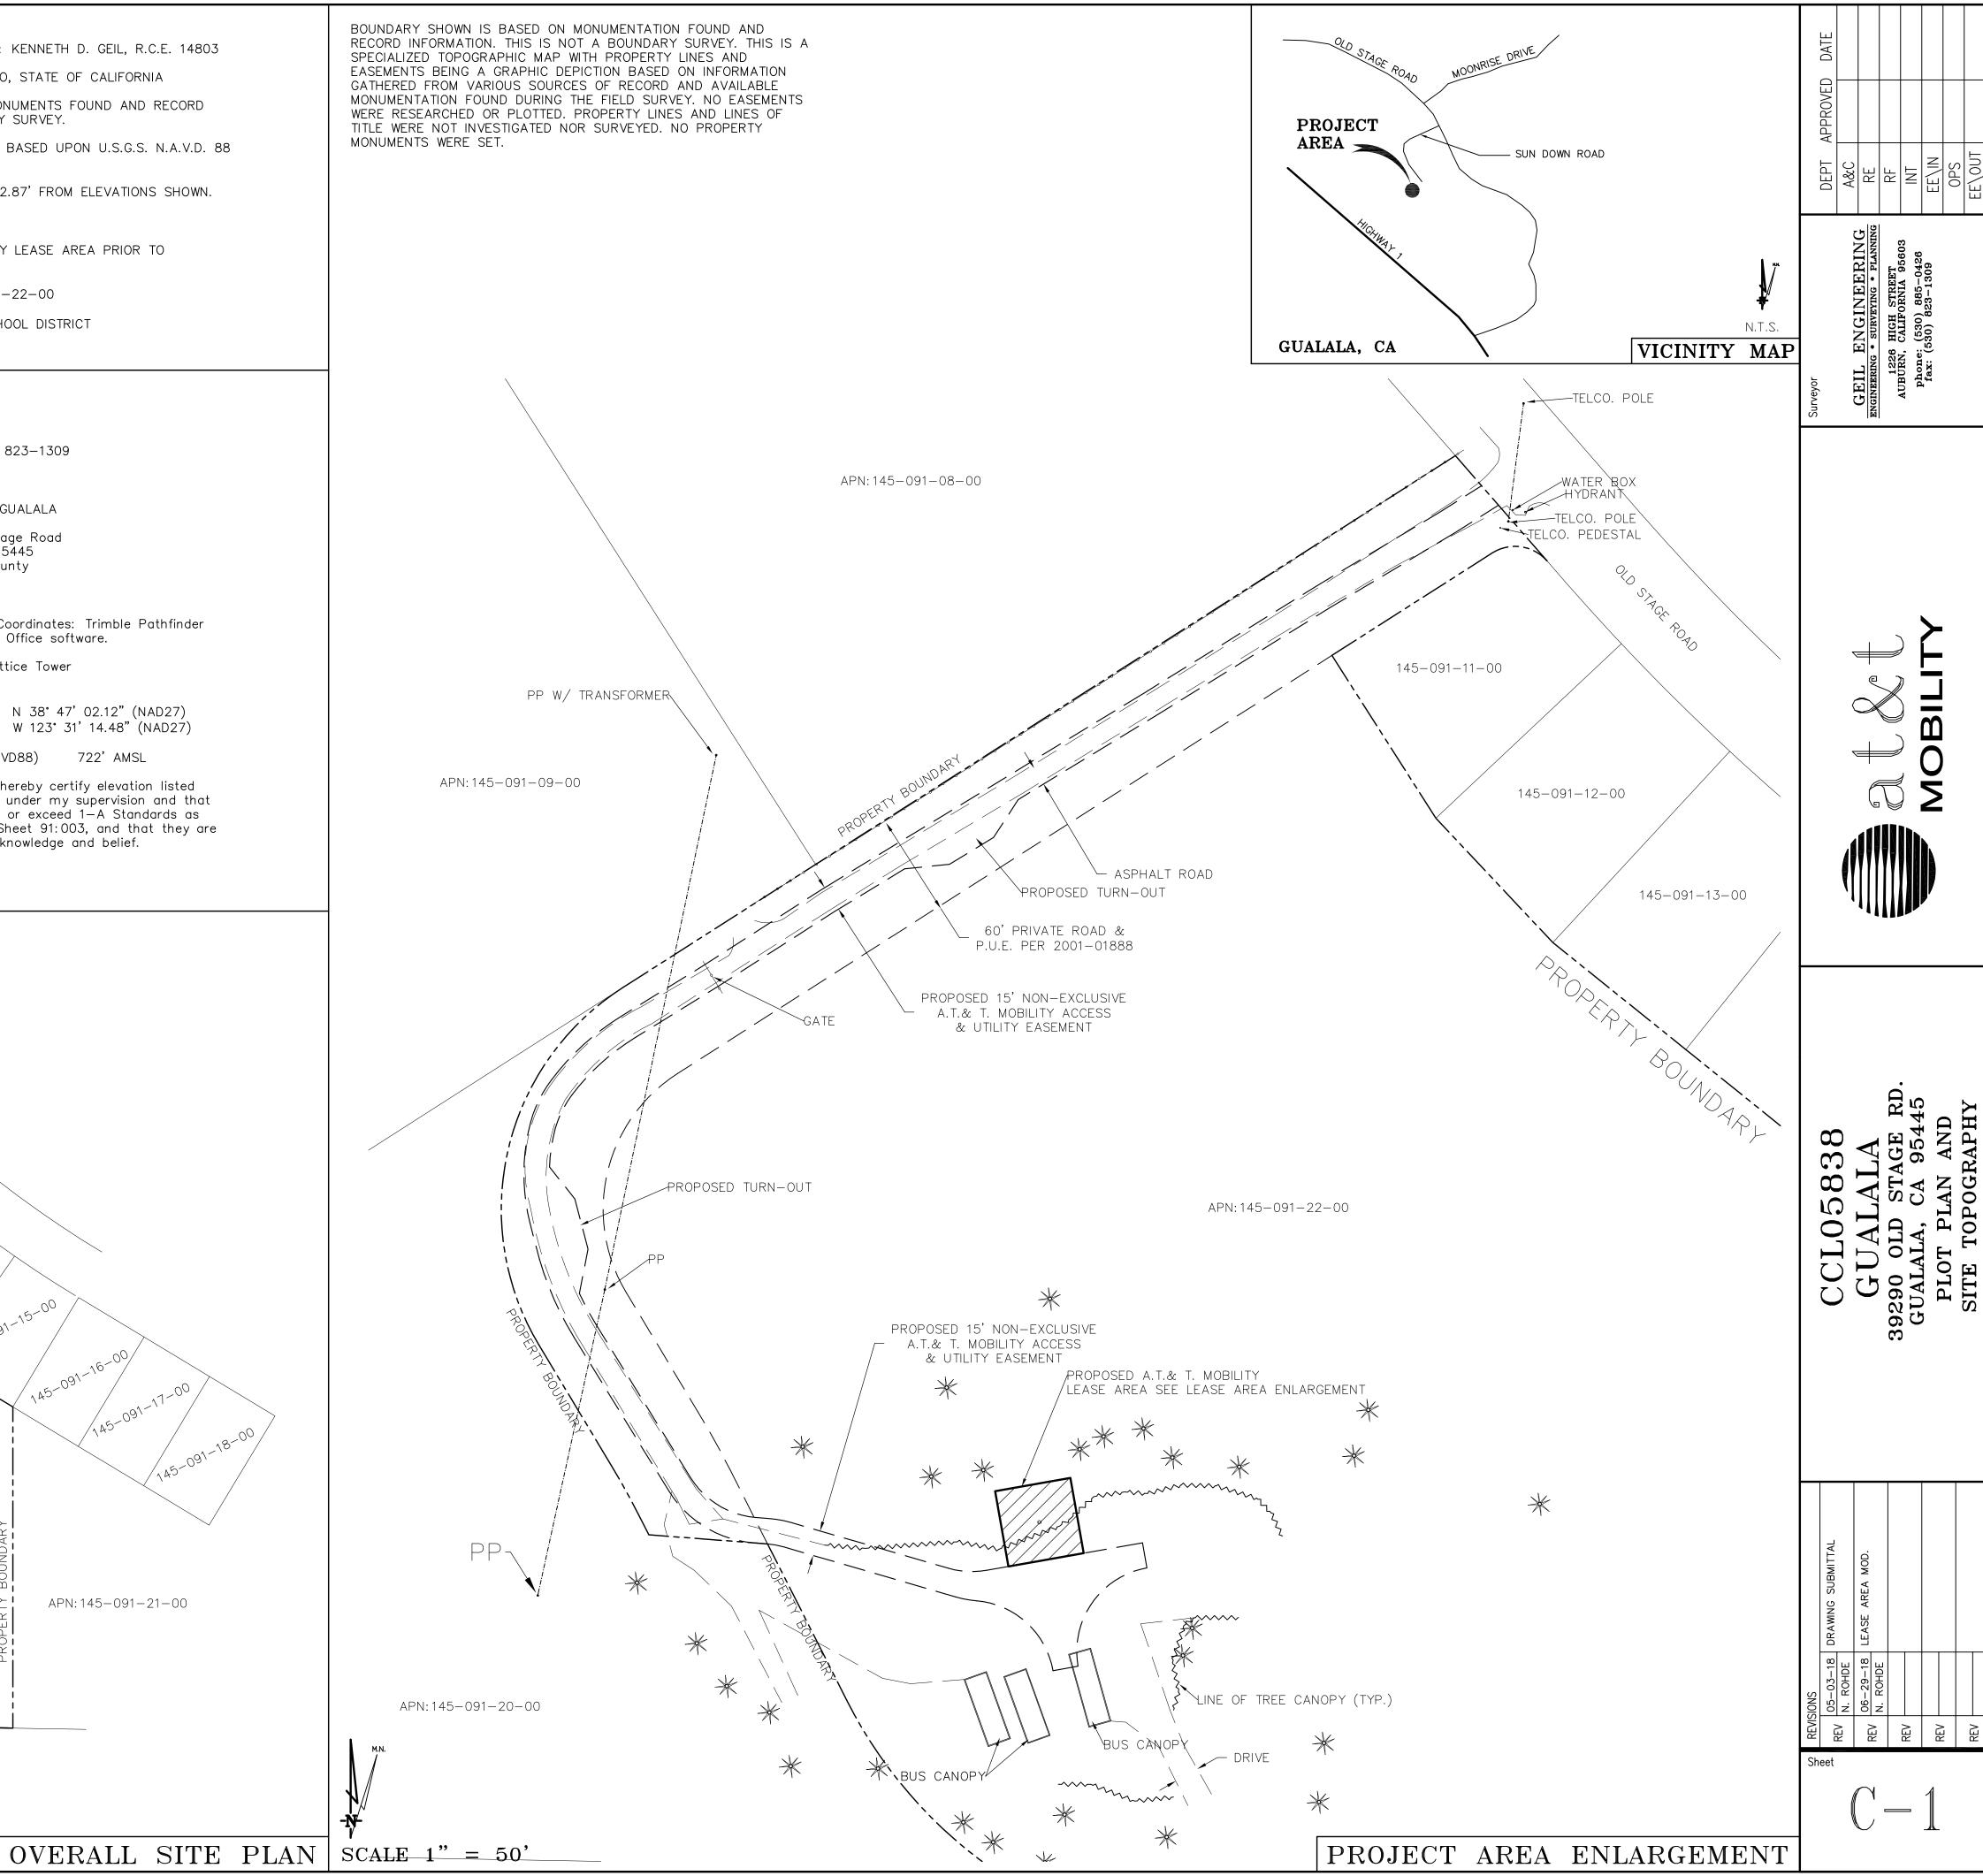

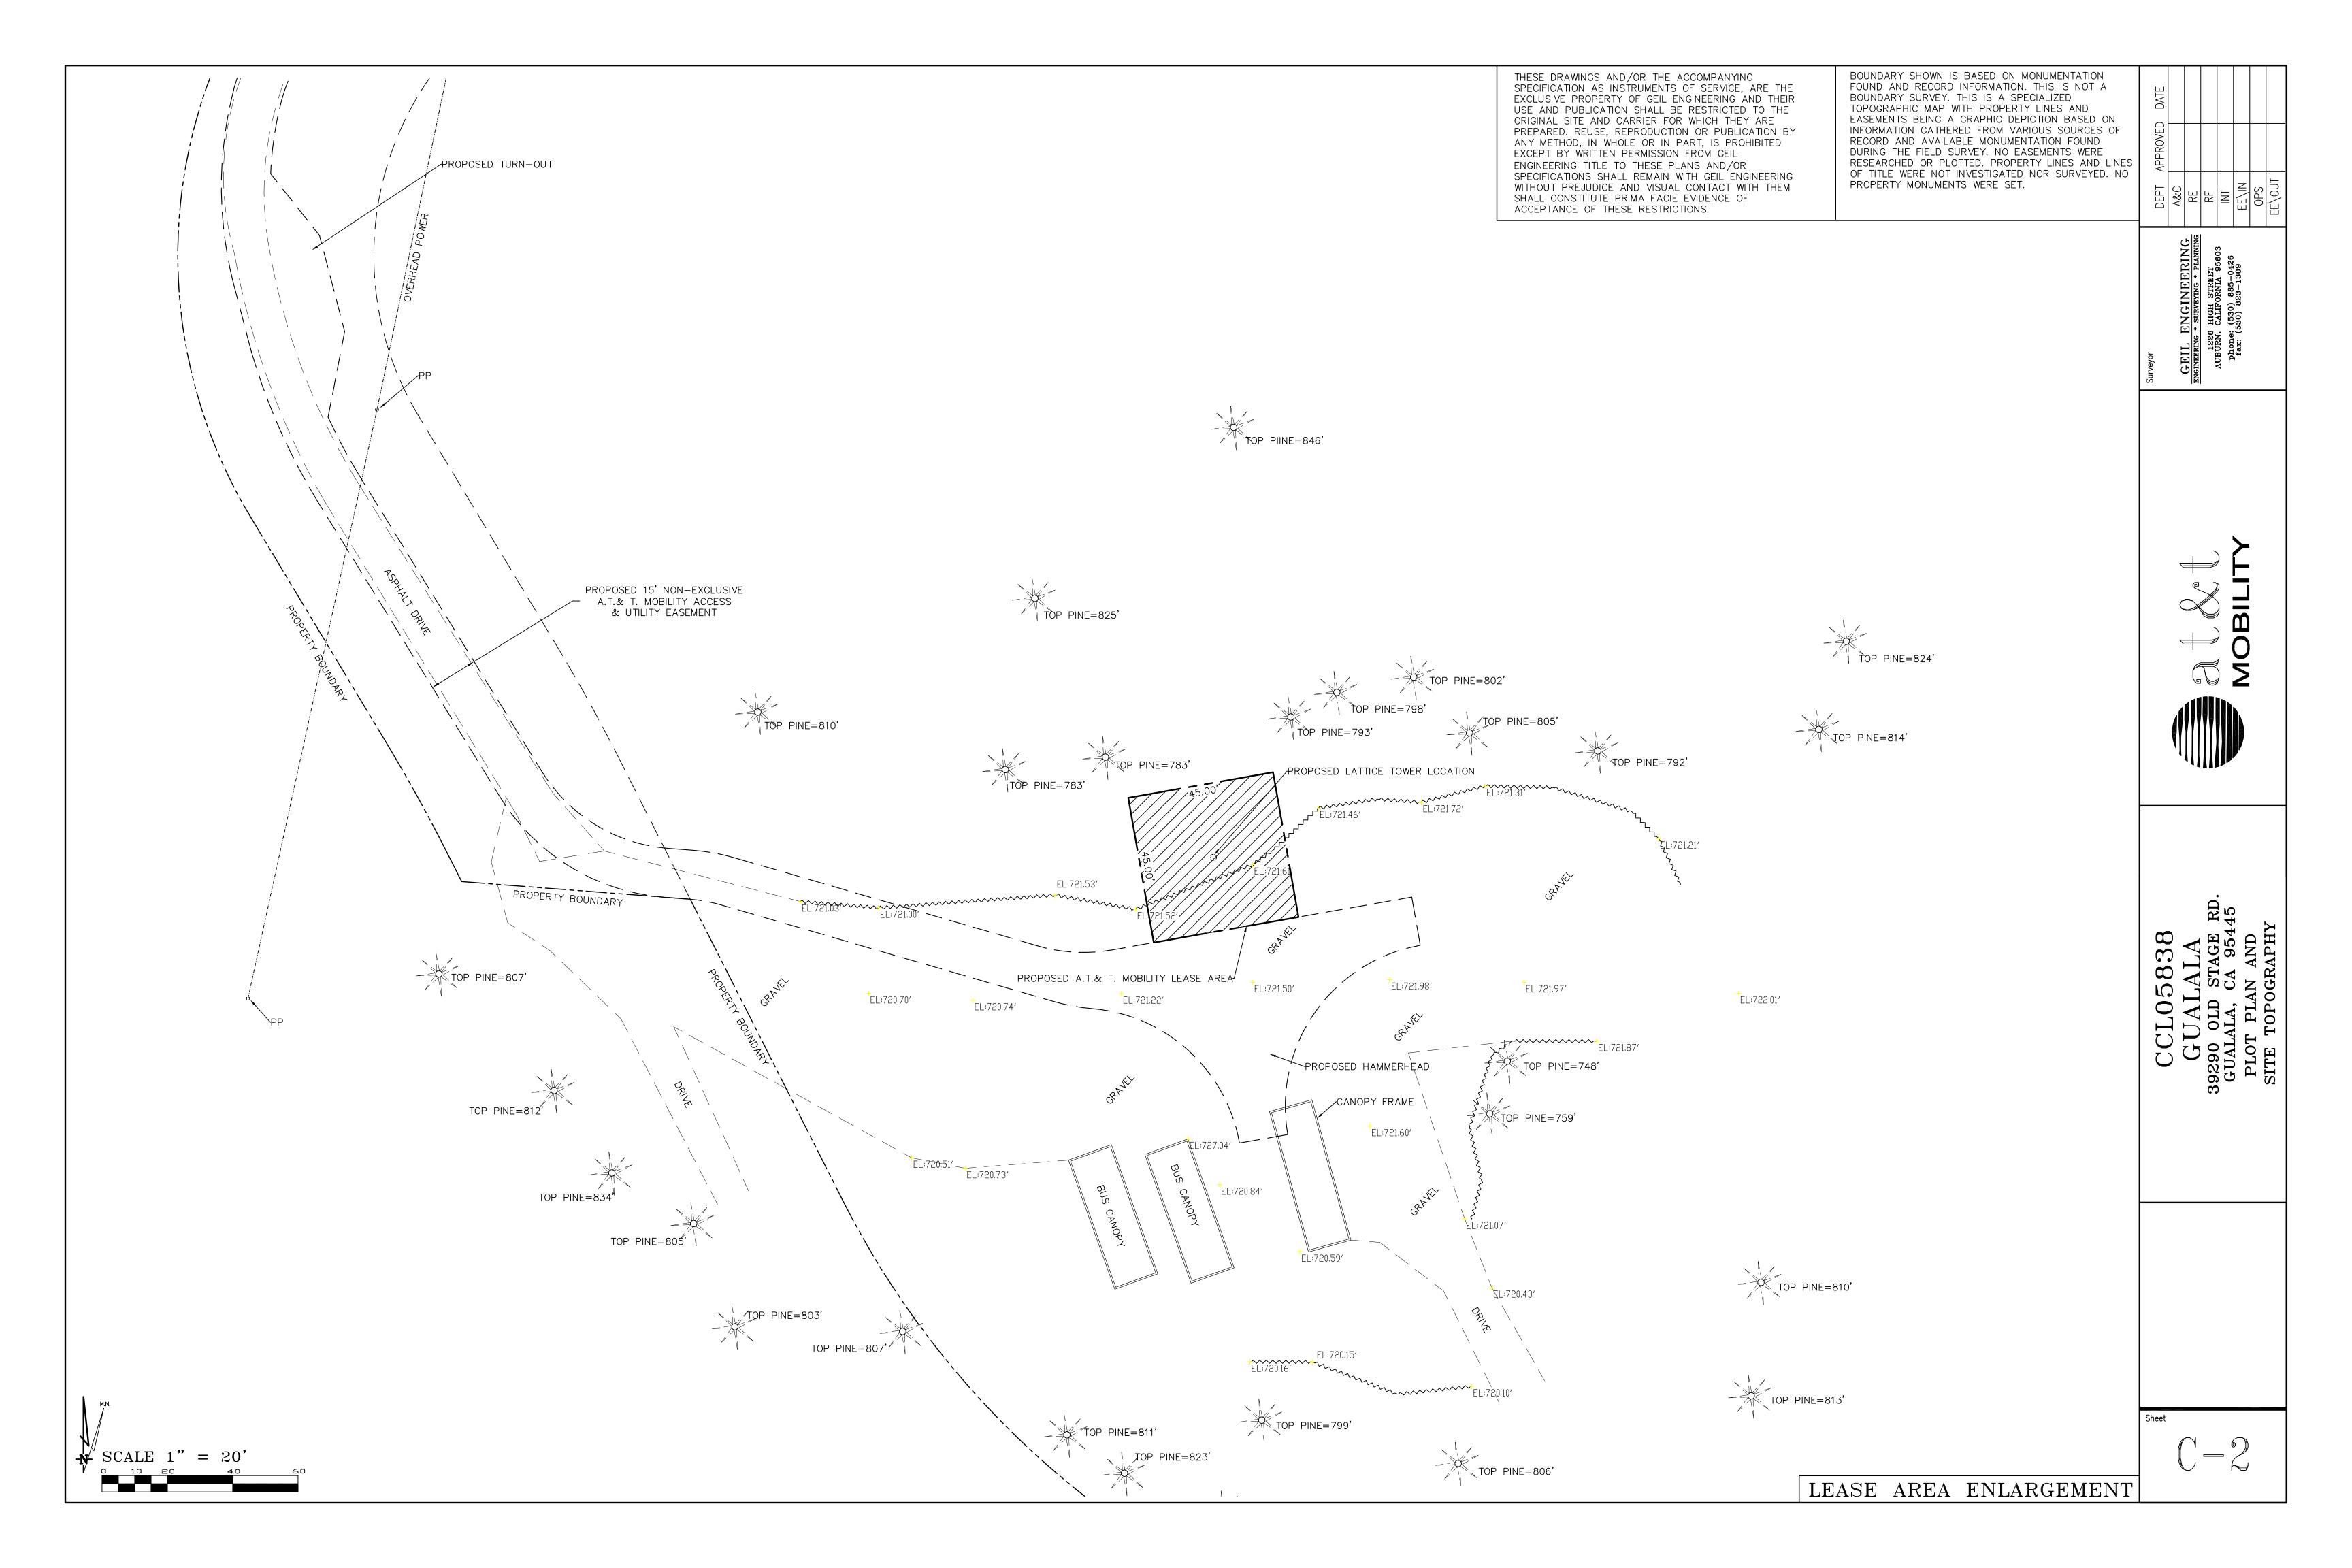

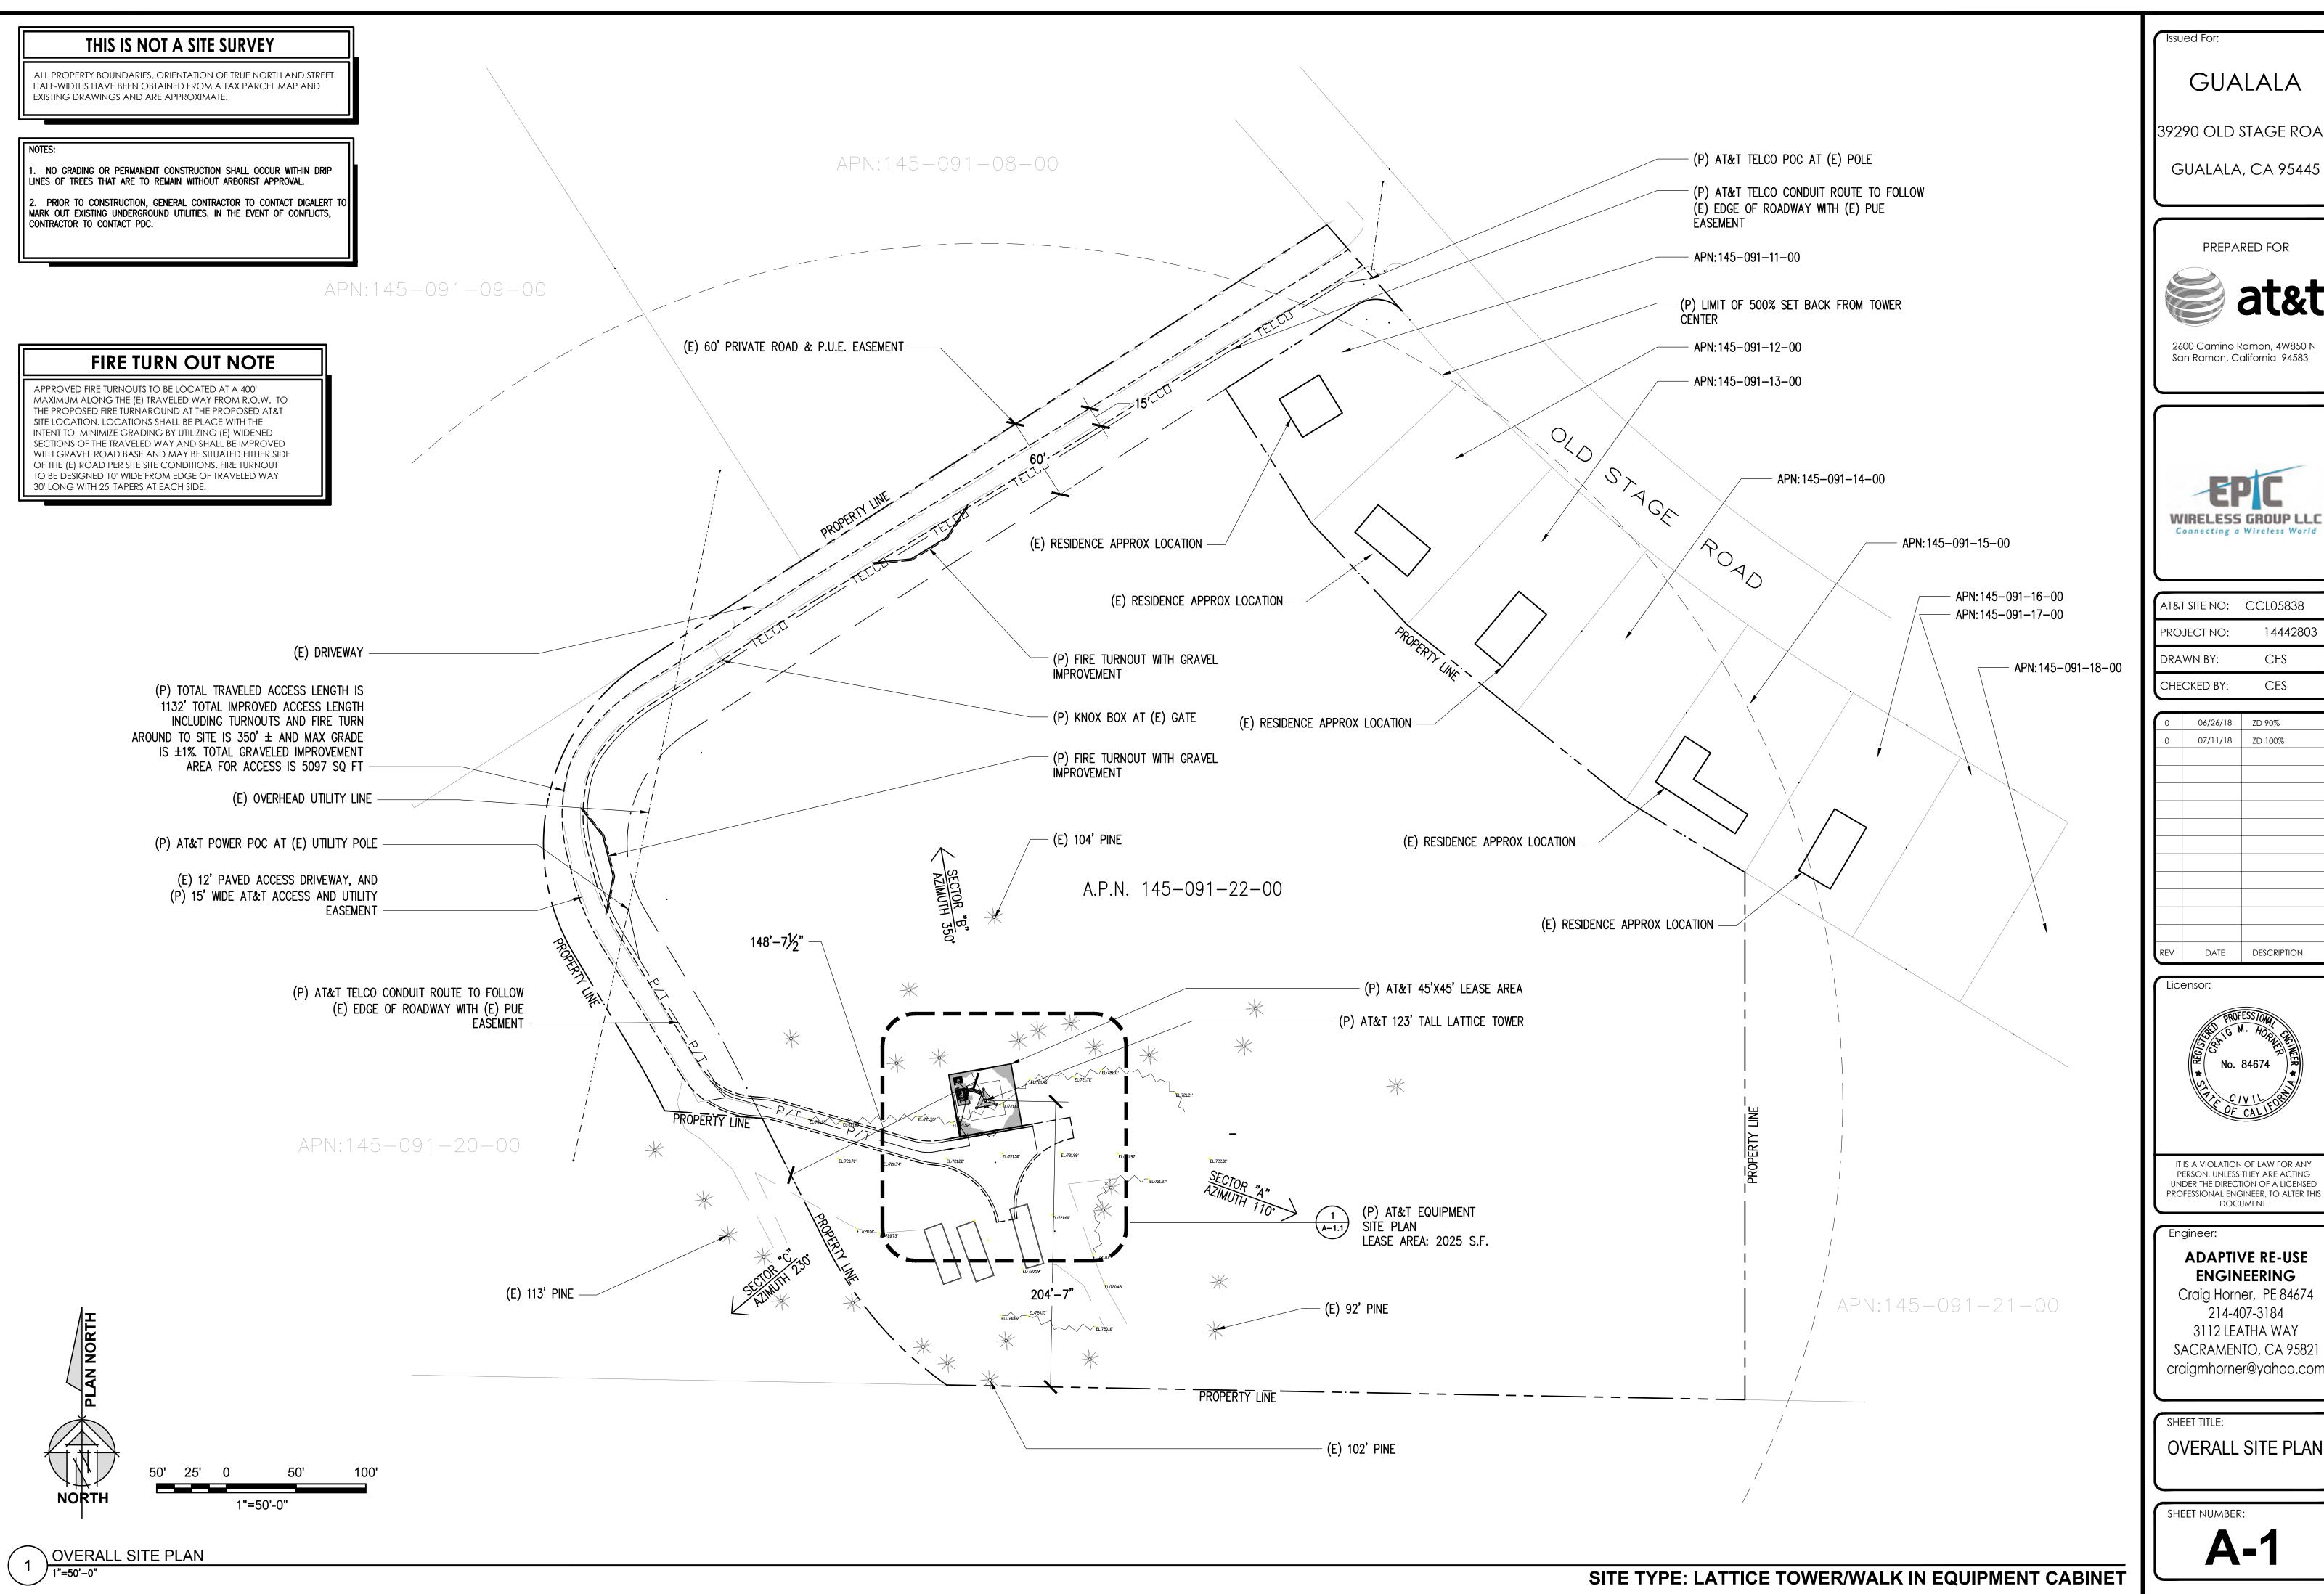

GUALALA

39290 OLD STAGE ROAD




2600 Camino Ramon, 4W850 N San Ramon, California 94583



AT&T SITE NO:	CCL05838
PROJECT NO:	14442803
DRAWN BY:	CES
CHECKED BY:	CES

0	06/26/18	ZD 90%
0	07/11/18	ZD 100%
REV	DATE	DESCRIPTION

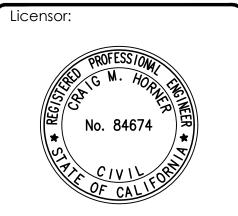

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Engineer:

## **ADAPTIVE RE-USE ENGINEERING**

Craig Horner, PE 84674 214-407-3184 3112 LEATHA WAY SACRAMENTO, CA 95821 craigmhorner@yahoo.com

OVERALL SITE PLAN

SHEET NUMBER:

**A-1** 




ALL PROPERTY BOUNDARIES, ORIENTATION OF TRUE NORTH AND STREET HALF-WIDTHS HAVE BEEN OBTAINED FROM A TAX PARCEL MAP AND EXISTING DRAWINGS AND ARE APPROXIMATE.

#### NOTES:

1. NO GRADING OR PERMANENT CONSTRUCTION SHALL OCCUR WITHIN DRIP LINES OF TREES THAT ARE TO REMAIN WITHOUT ARBORIST APPROVAL.

2. PRIOR TO CONSTRUCTION, GENERAL CONTRACTOR TO CONTACT DIGALERT TO MARK OUT EXISTING UNDERGROUND UTILITIES. IN THE EVENT OF CONFLICTS, CONTRACTOR TO CONTACT PDC.



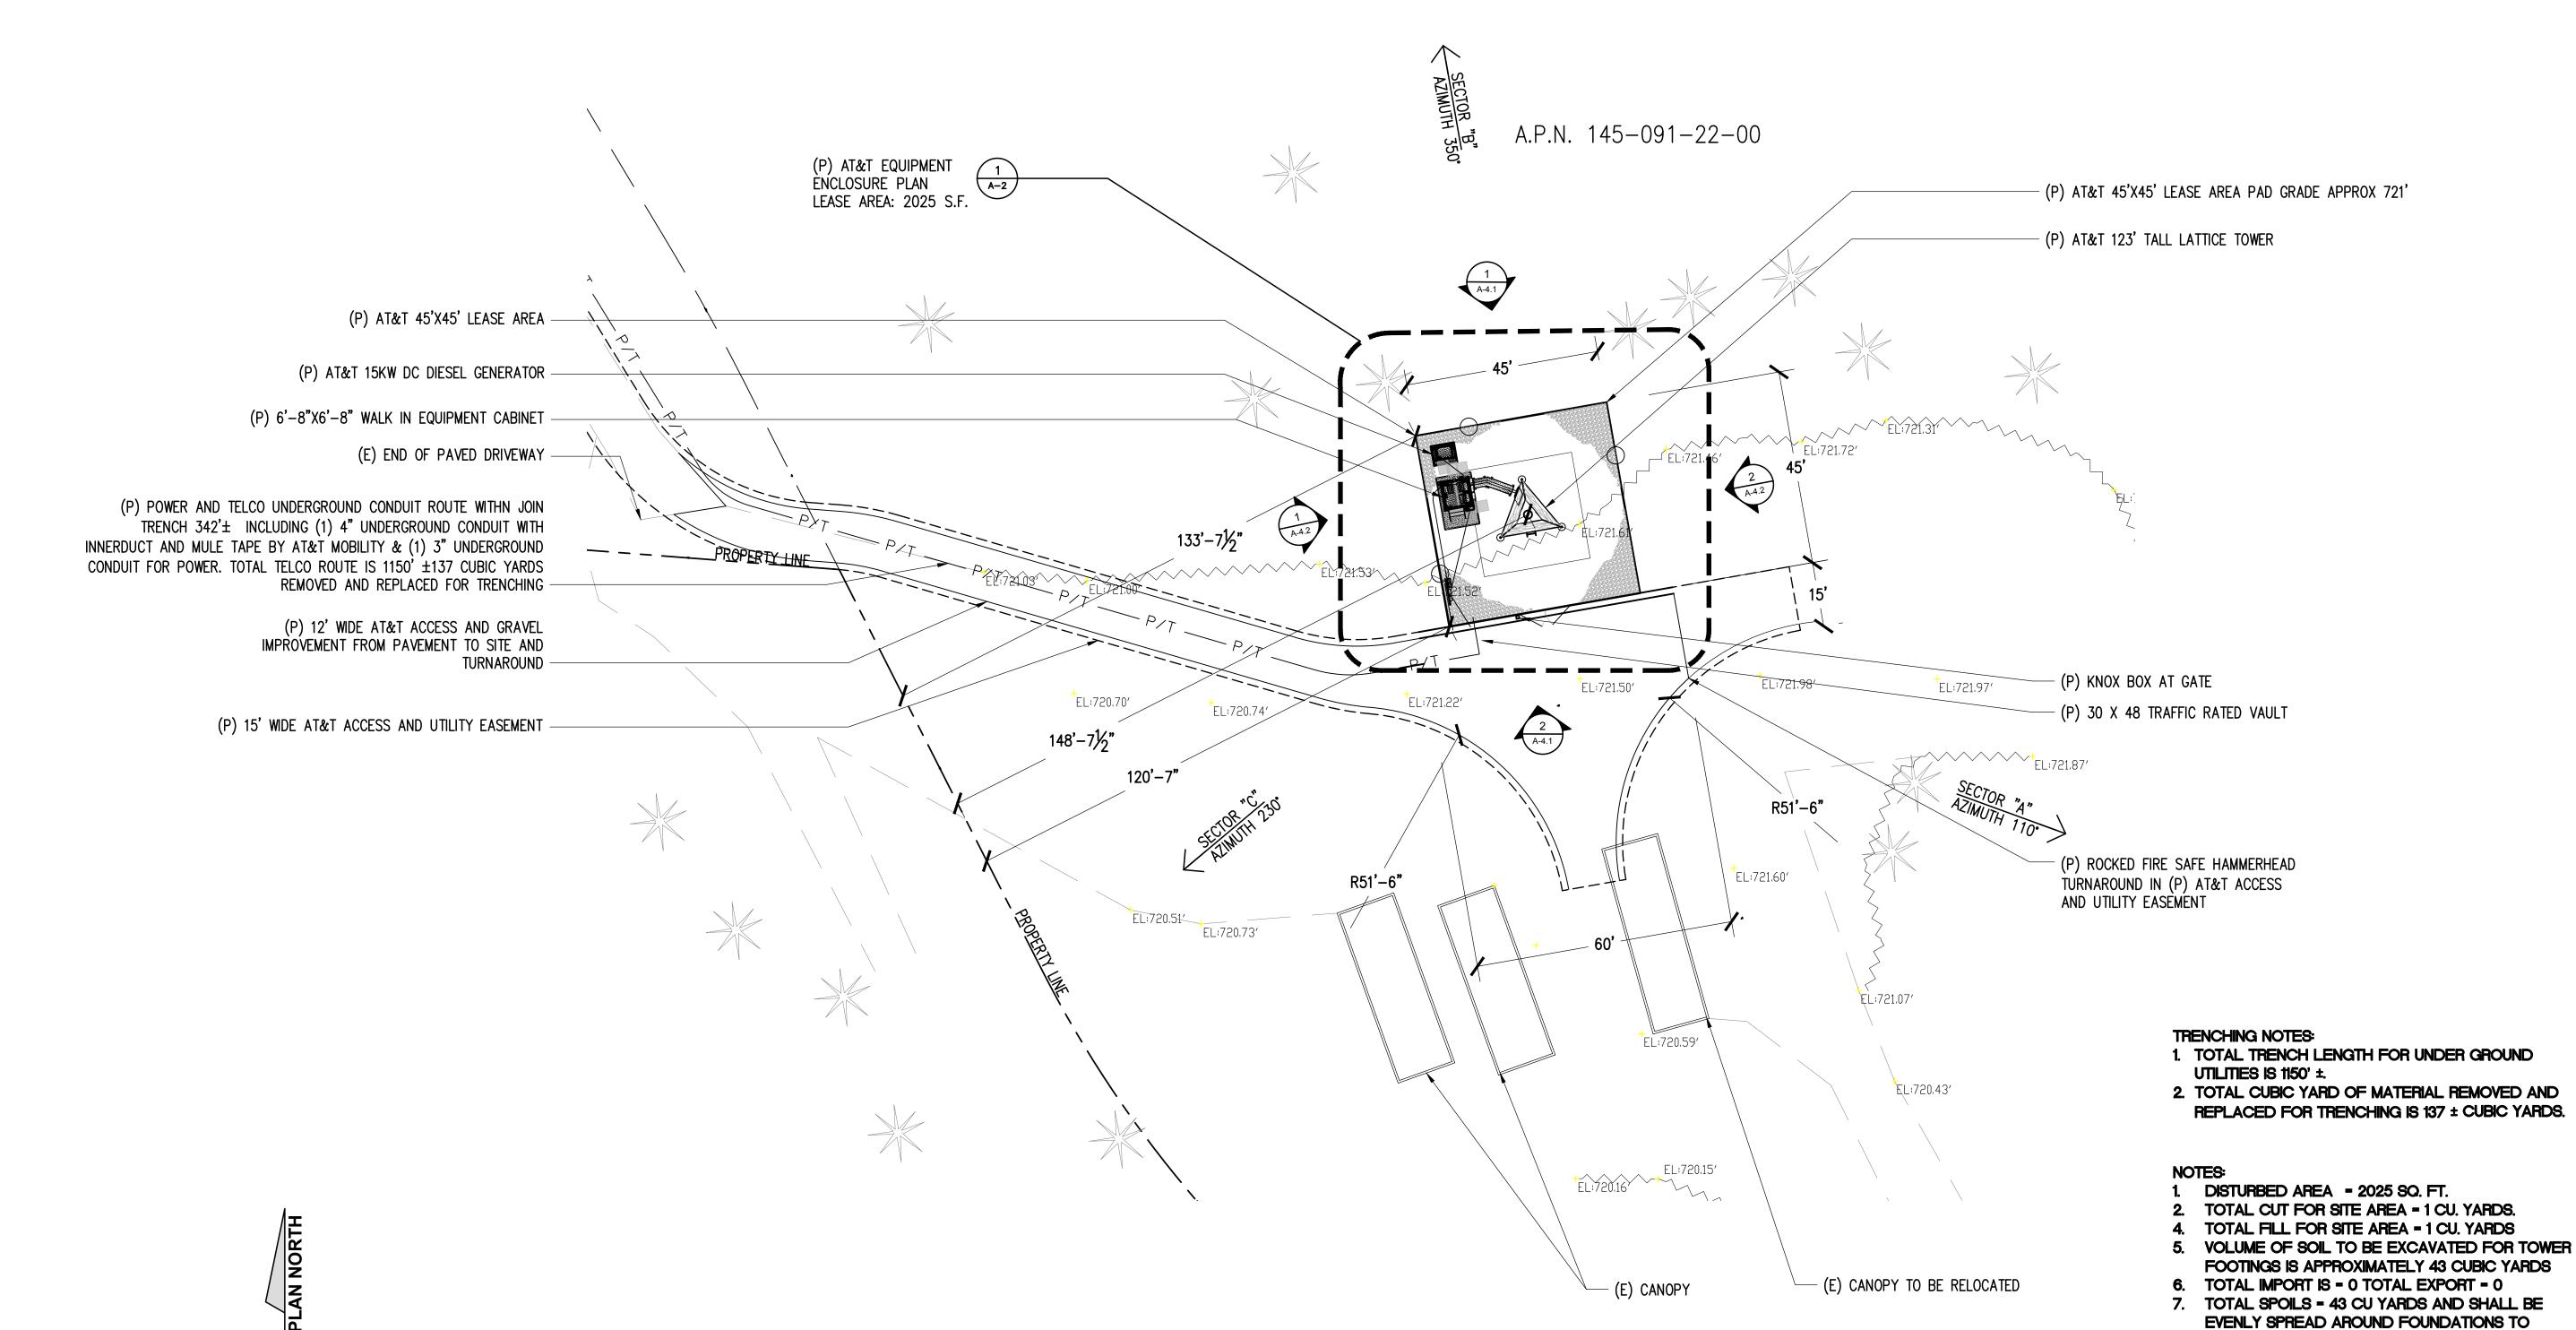

Issued For:

GUALALA

39290 OLD STAGE ROAD

GUALALA, CA 95445

PREPARED FOR




2600 Camino Ramon, 4W850 N San Ramon, California 94583



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## ADAPTIVE RE-USE ENGINEERING

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SHEET TITLE:

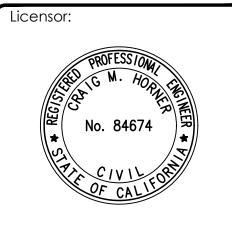SITE PLAN

SHEET NUMBER:

SITE TYPE: LATTICE TOWER/WALK IN EQUIPMENT CABINET

DIVERT WATER AWAY FROM STRUCTURES AND OR


EVENLY SPREAD ON SITE IN A MANNER AS NOT TO

DISRUPT EXISTING FLOW PATTERNS.

8. MAX SLOPE NOT TO EXCEED 2:1 AND MAX HEIGHT OF CUT OR FILL SLOPE IS 0".

1 SITE PLAN
1"=20'-0"

1"=20'-0"

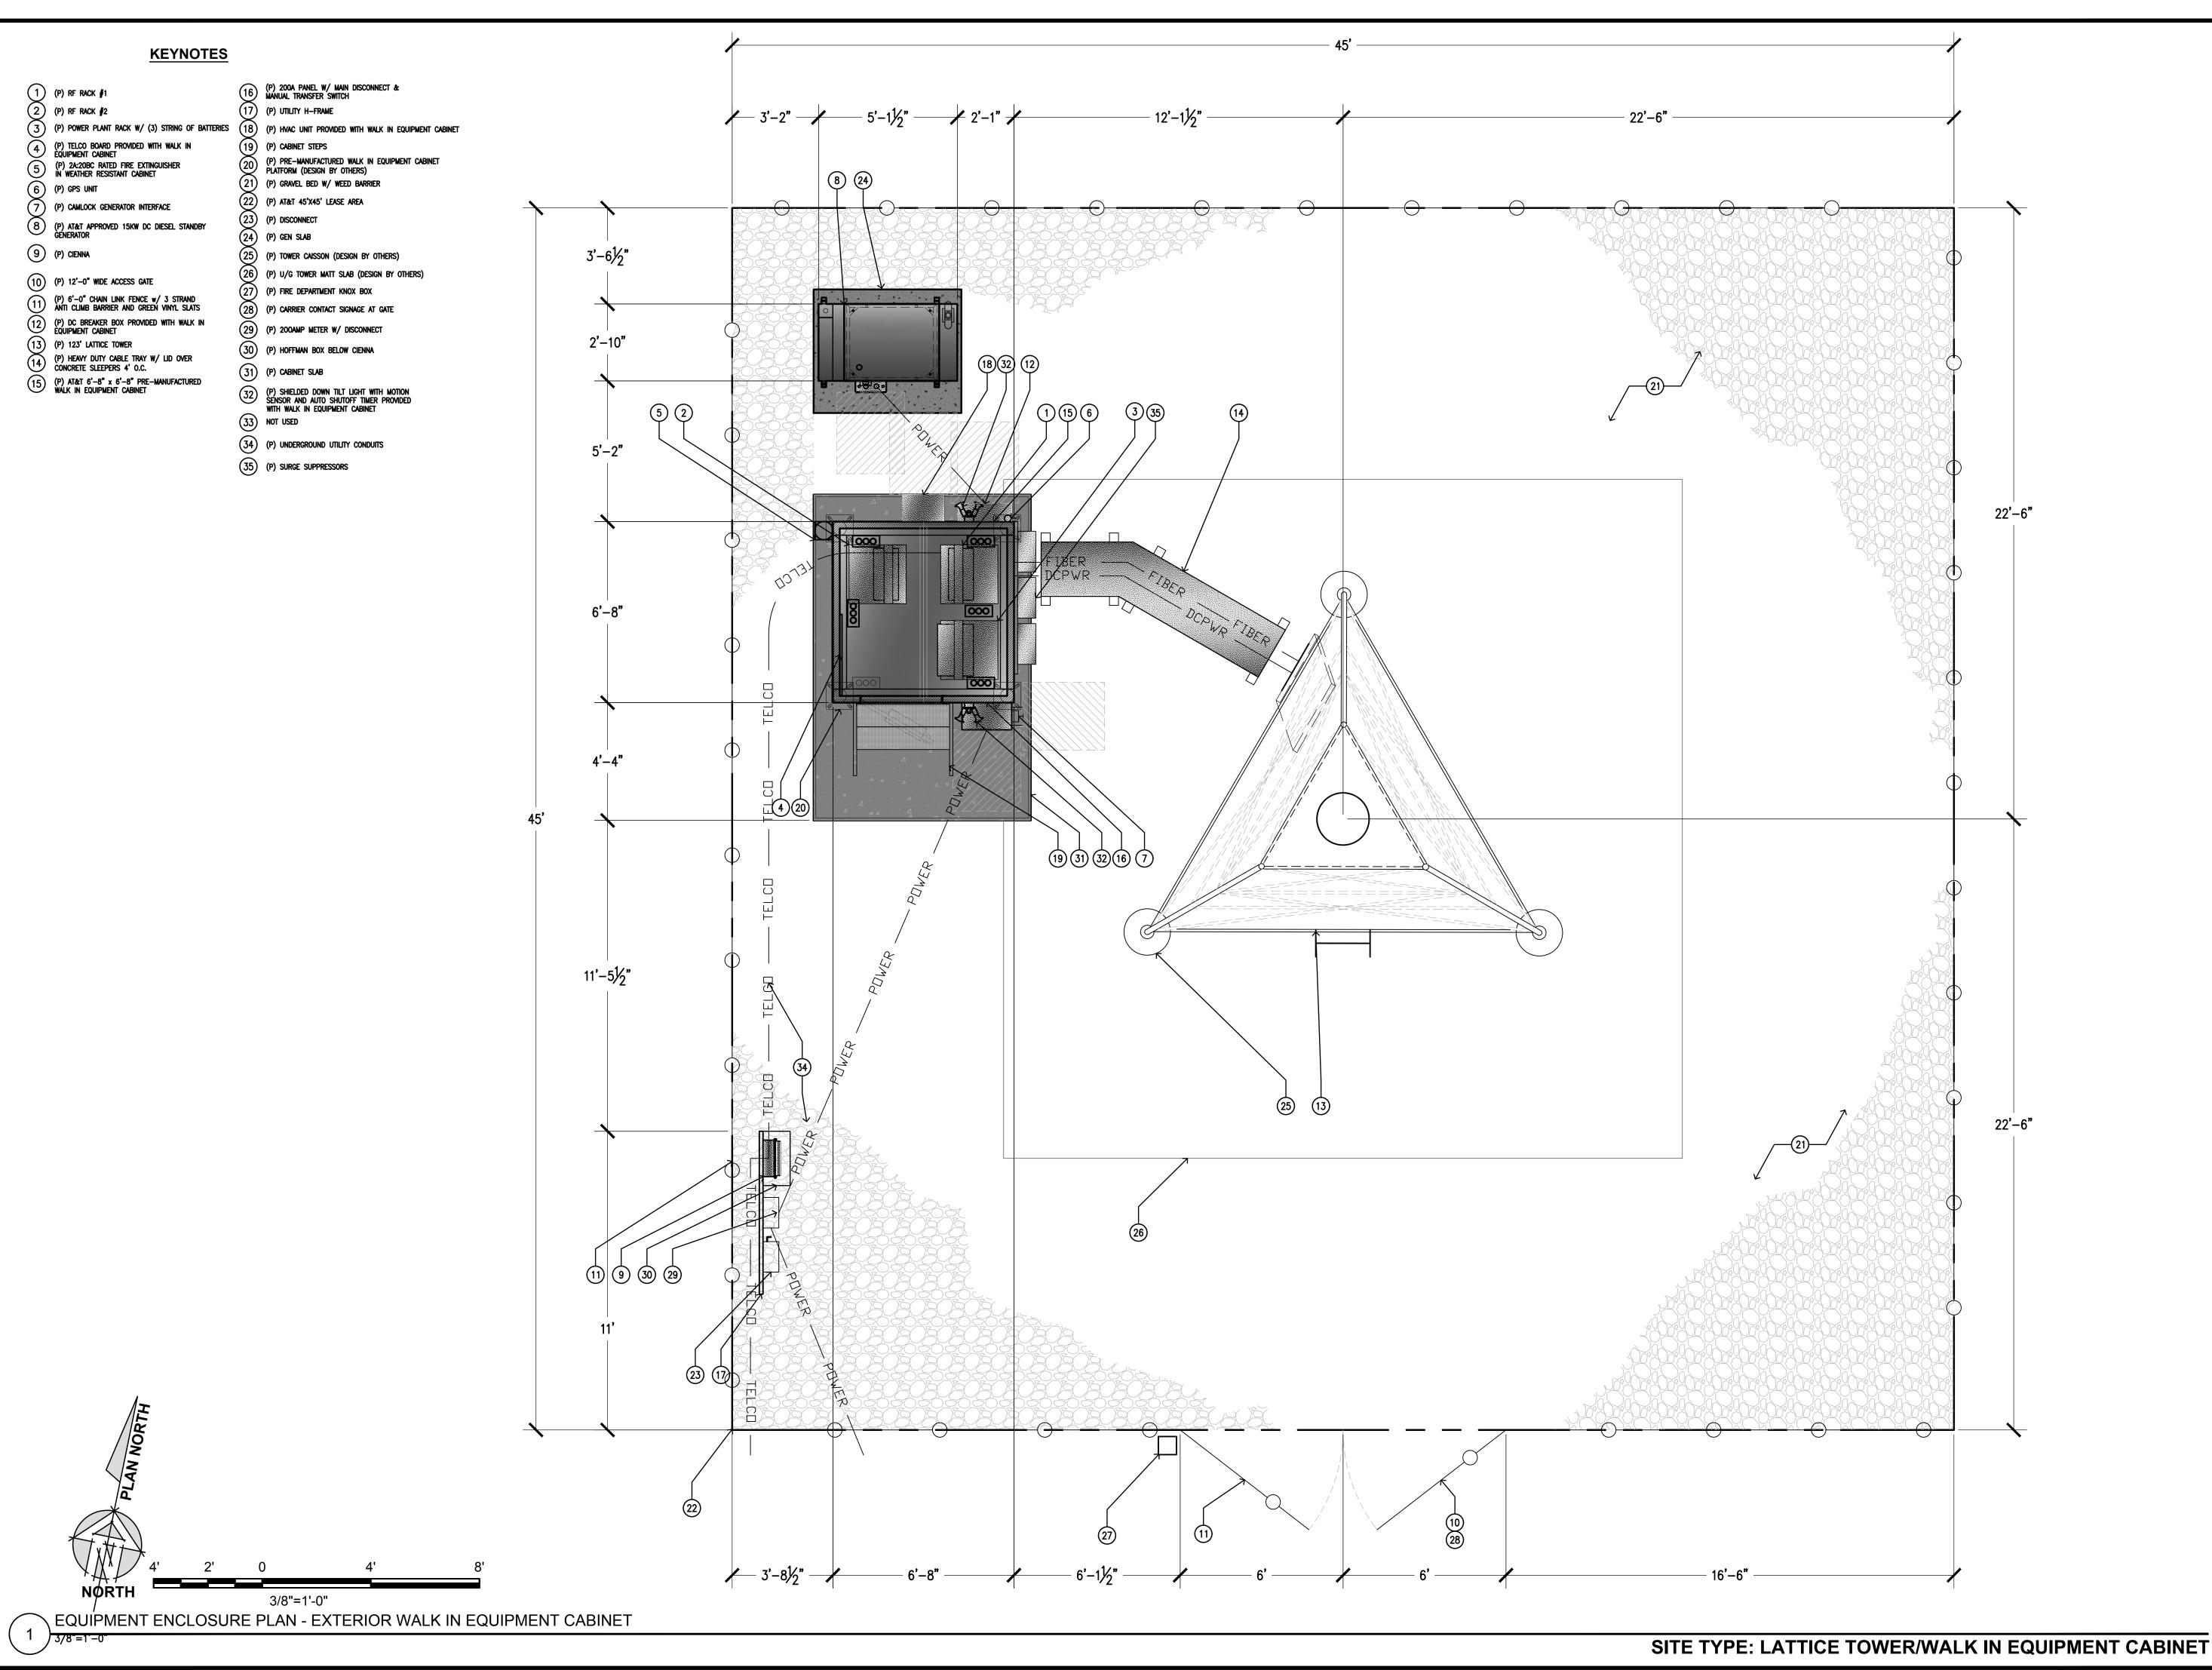

GUALALA

39290 OLD STAGE ROAD

GUALALA, CA 95445

PREPARED FOR




San Ramon, California 94583



AT&T SITE NO:	CCL05838
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06/26/18	ZD 90%
	LD 70/0
07/11/18	ZD 100%
DATE	DESCRIPTION

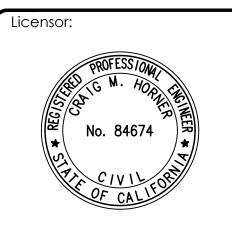


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**EQUIPMENT AREA** PLAN



39290 OLD STAGE ROAD

PREPARED FOR

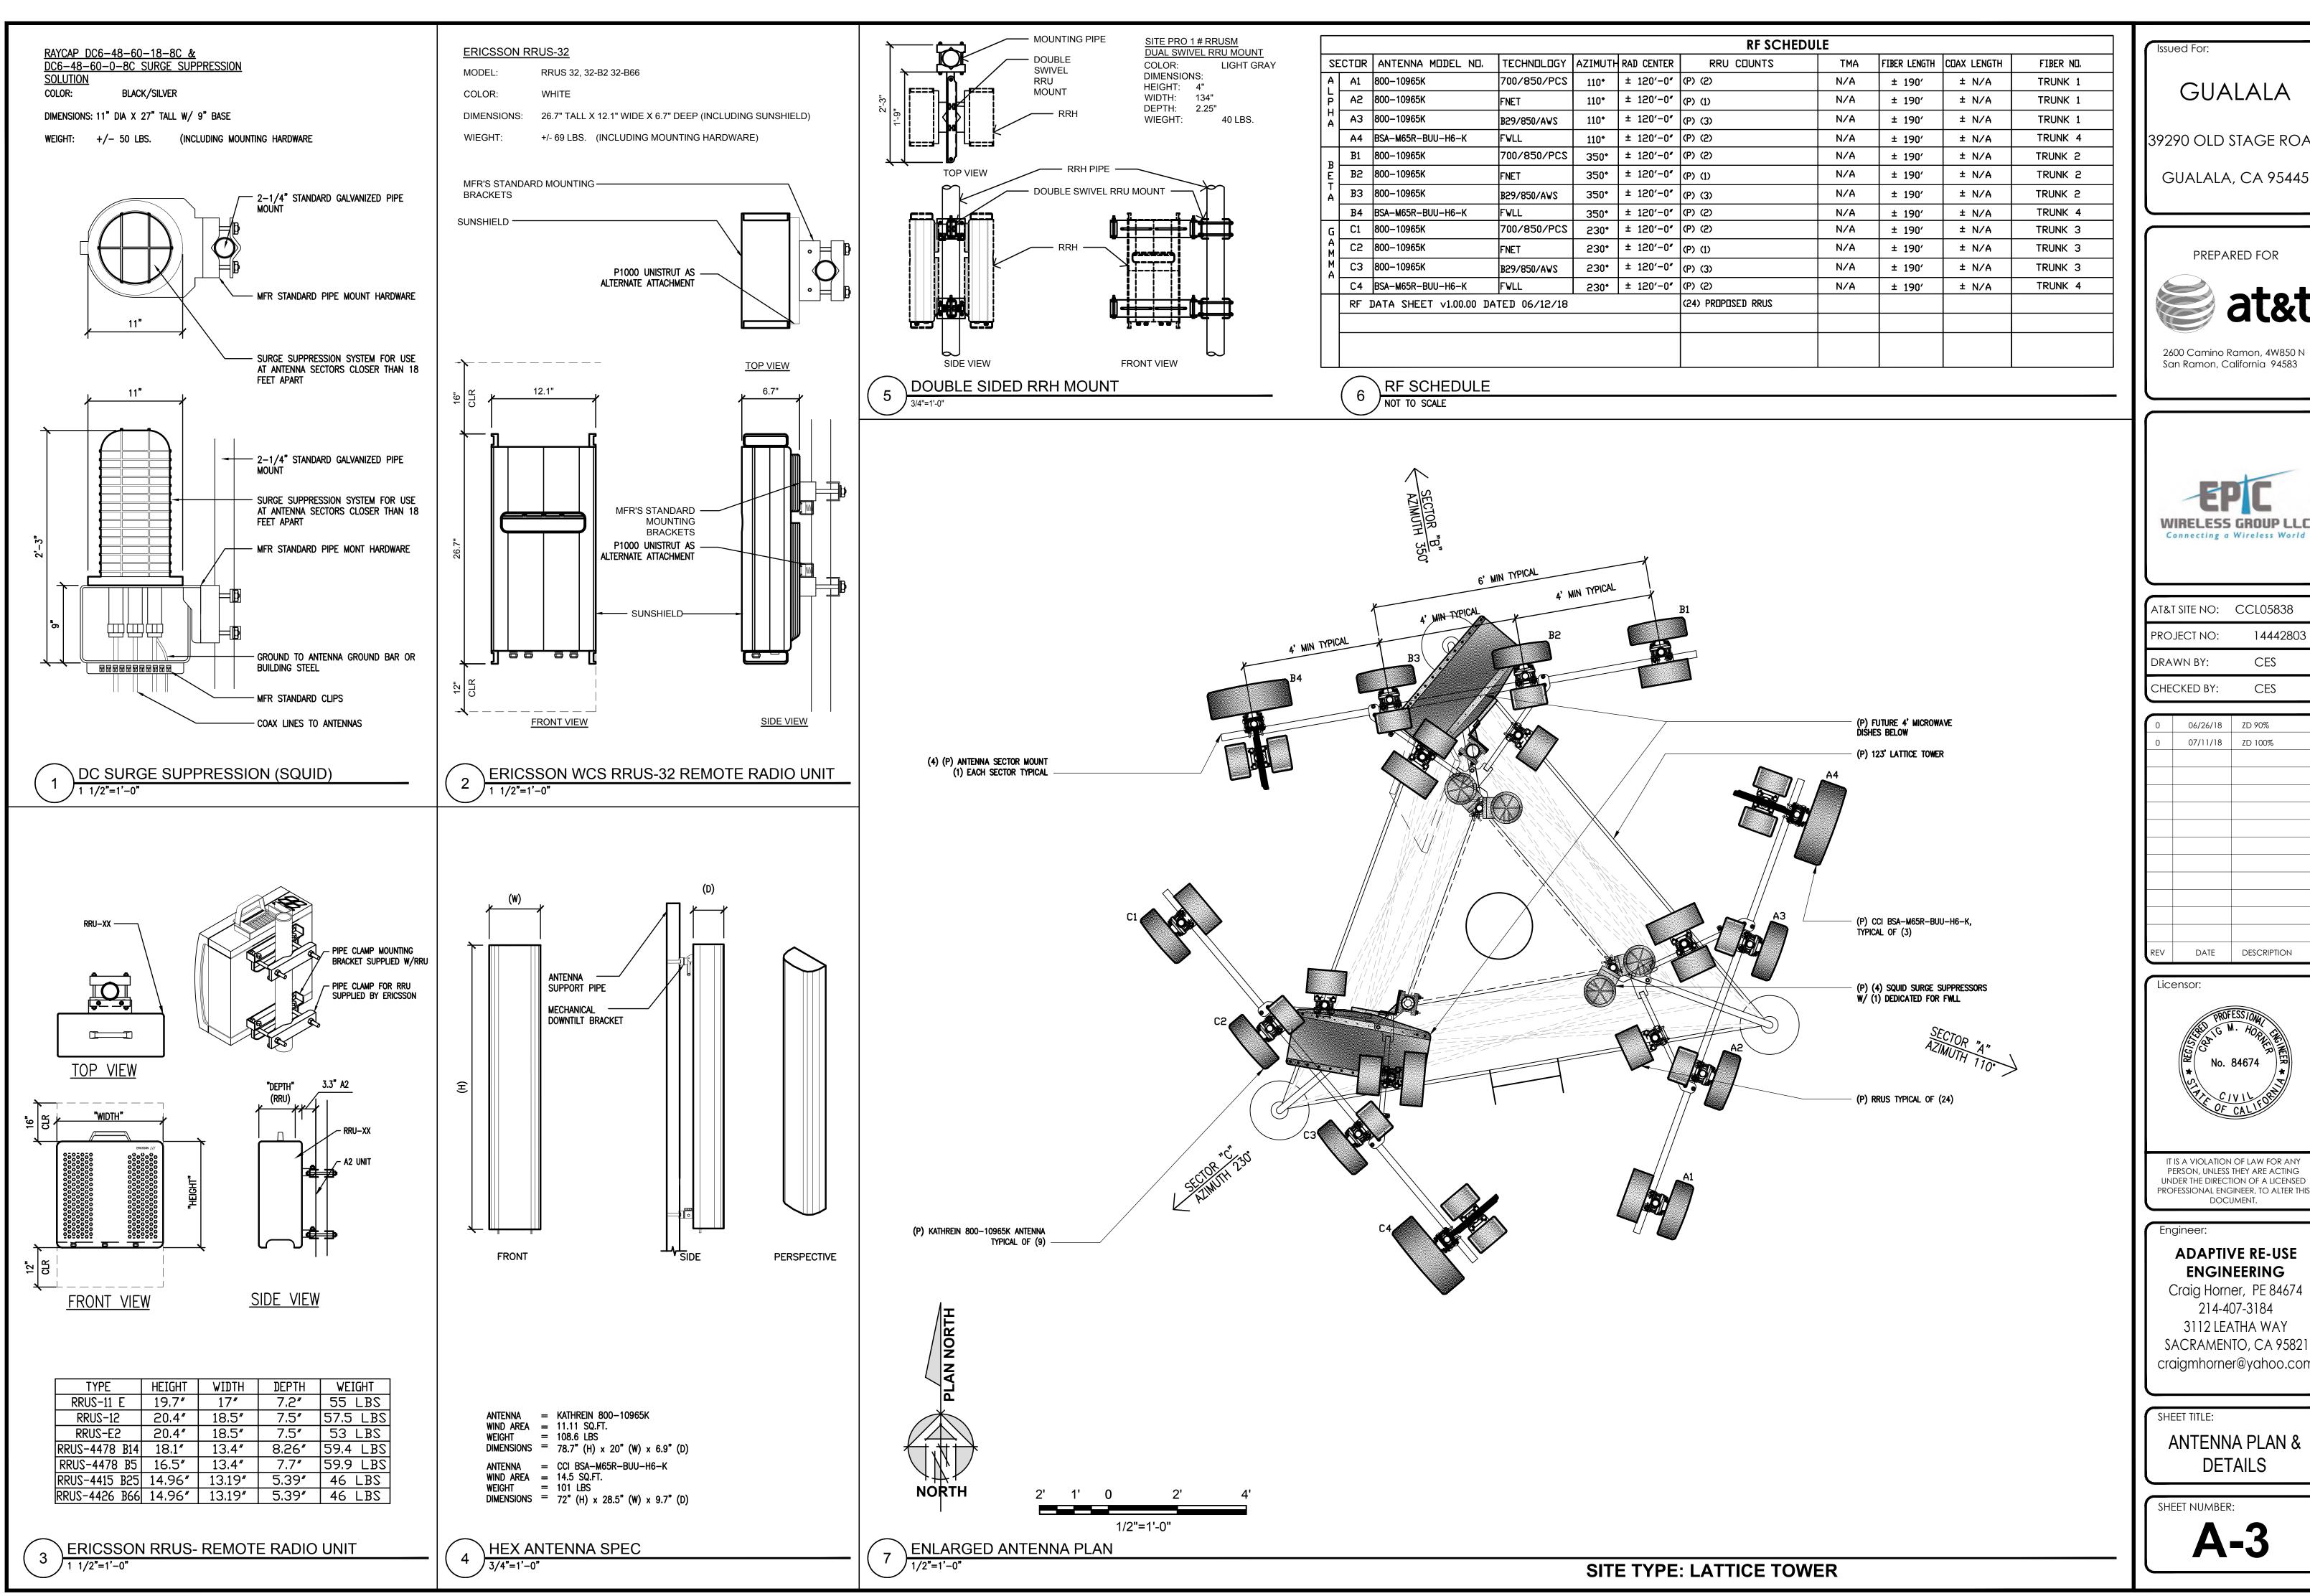


2600 Camino Ramon, 4W850 N San Ramon, California 94583



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PROJECT NO:	14442803
DRAWN BY:	CES
CHECKED BY:	CES

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REV	DATE	DESCRIPTION

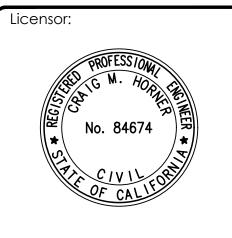

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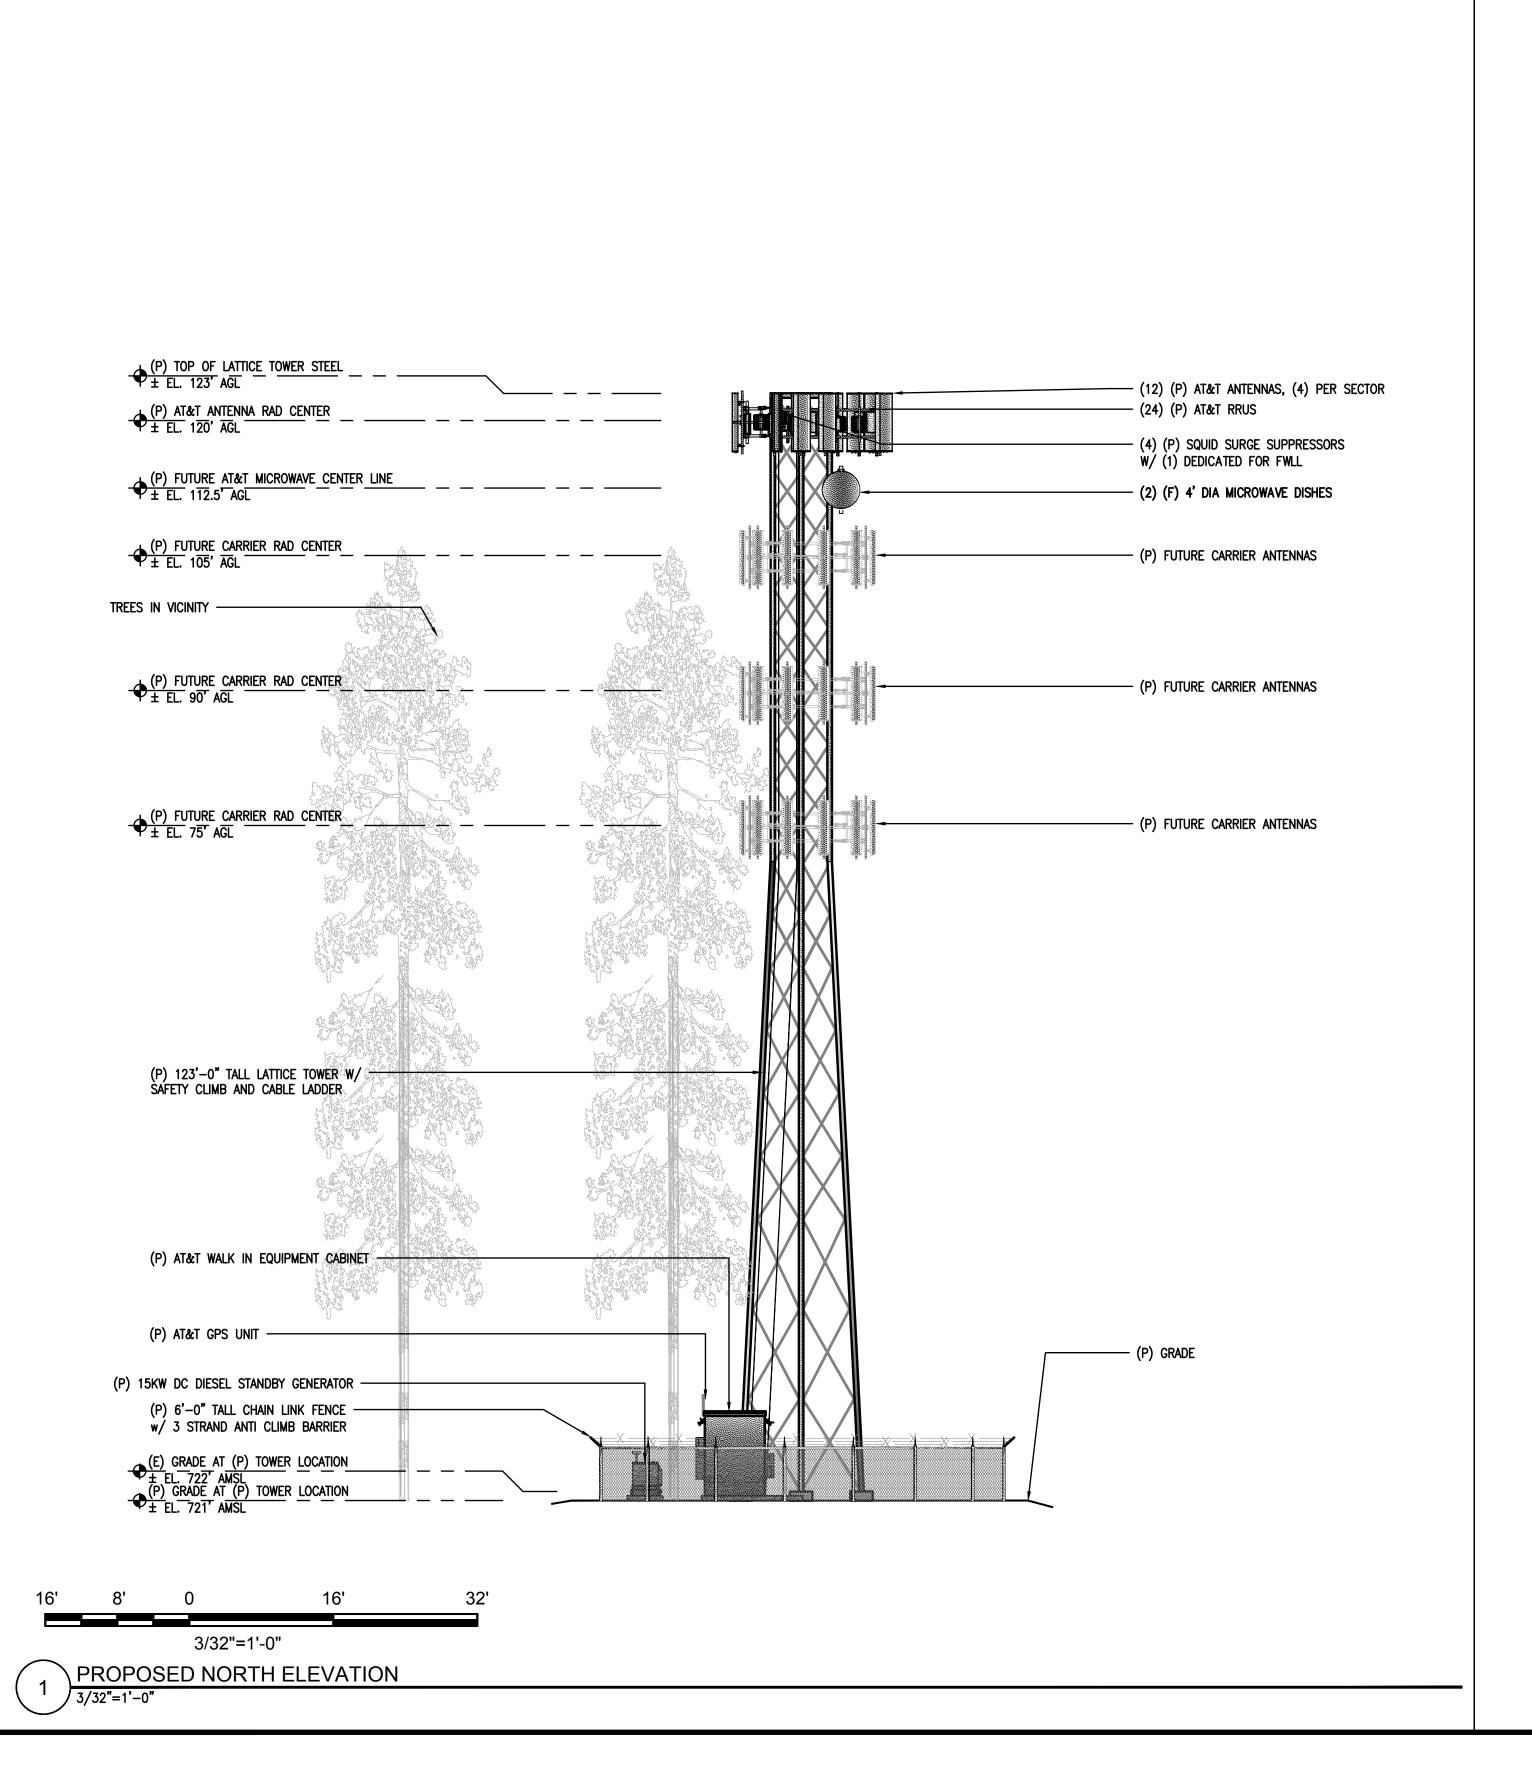
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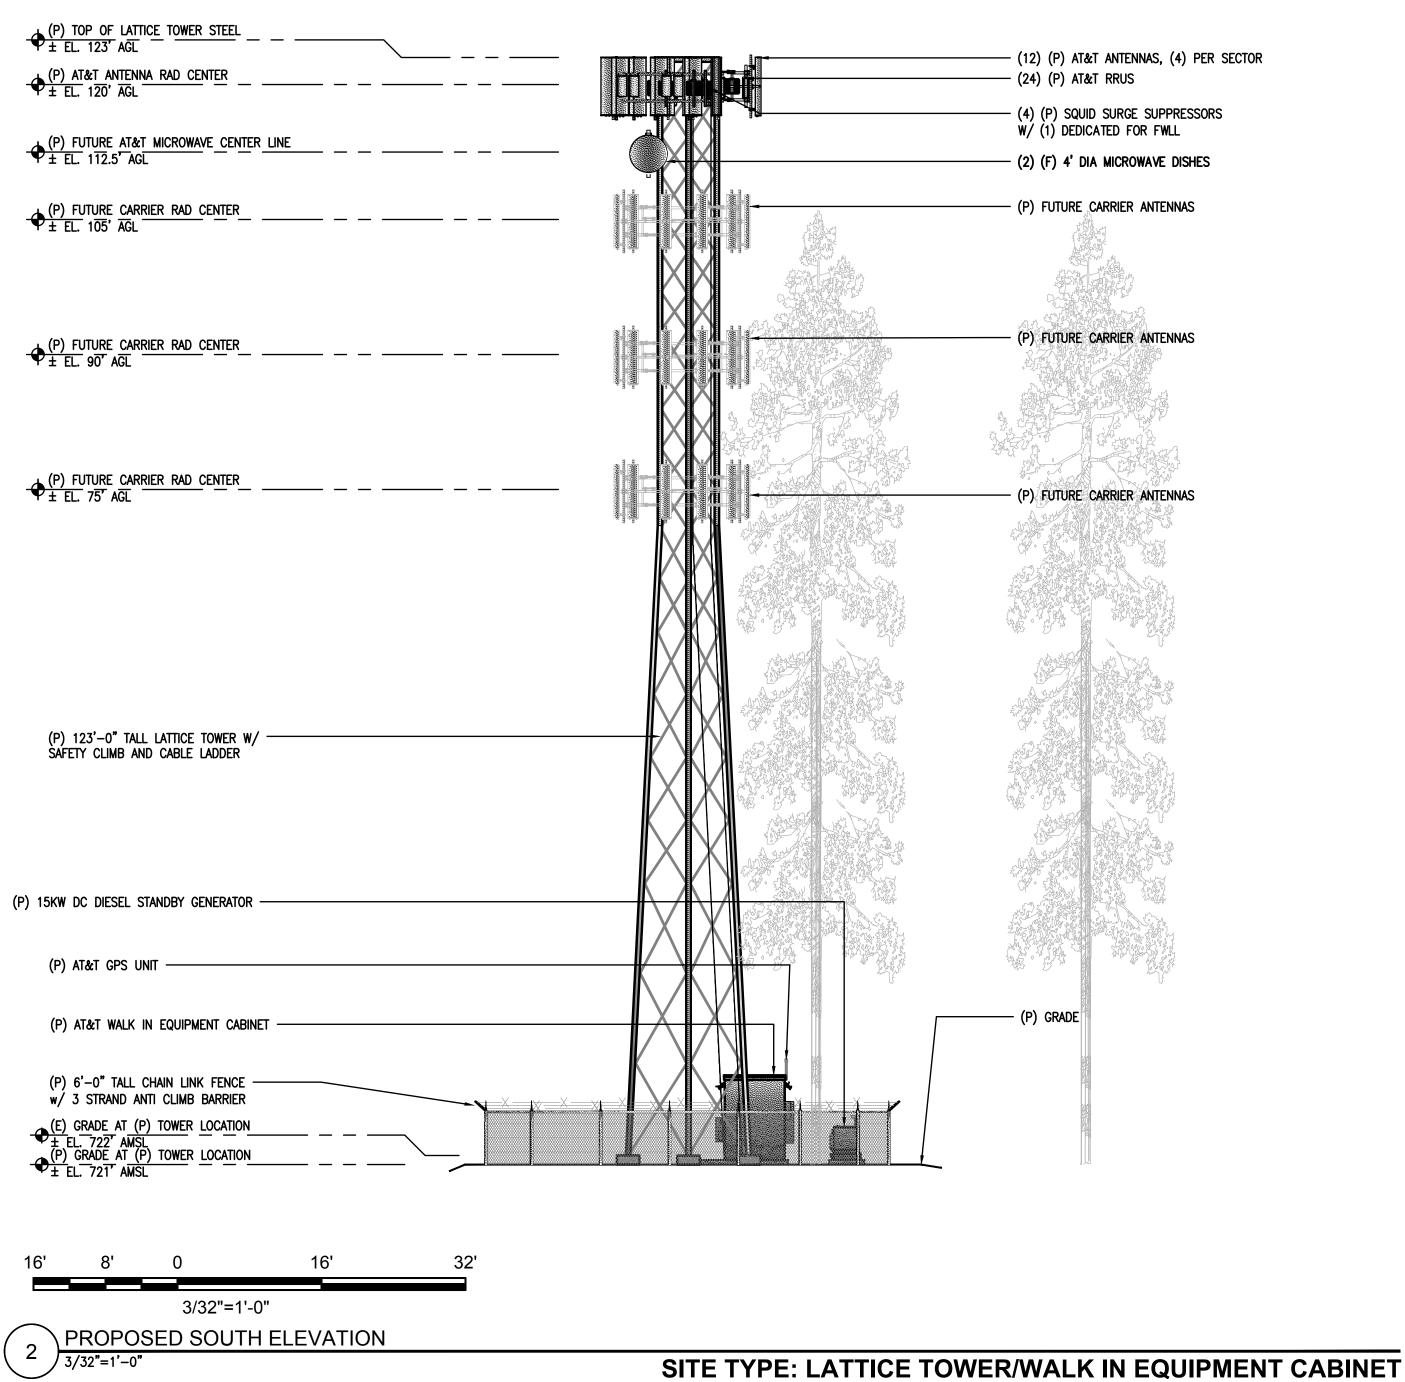
## **ADAPTIVE RE-USE ENGINEERING**

Craig Horner, PE 84674 214-407-3184 3112 LEATHA WAY SACRAMENTO, CA 95821 craigmhorner@yahoo.com

SHEET TITLE:

**ANTENNA PLAN & DETAILS** 





GUALALA

39290 OLD STAGE ROAD

GUALALA, CA 95445

PREPARED FOR




2600 Camino Ramon, 4W850 N San Ramon, California 94583



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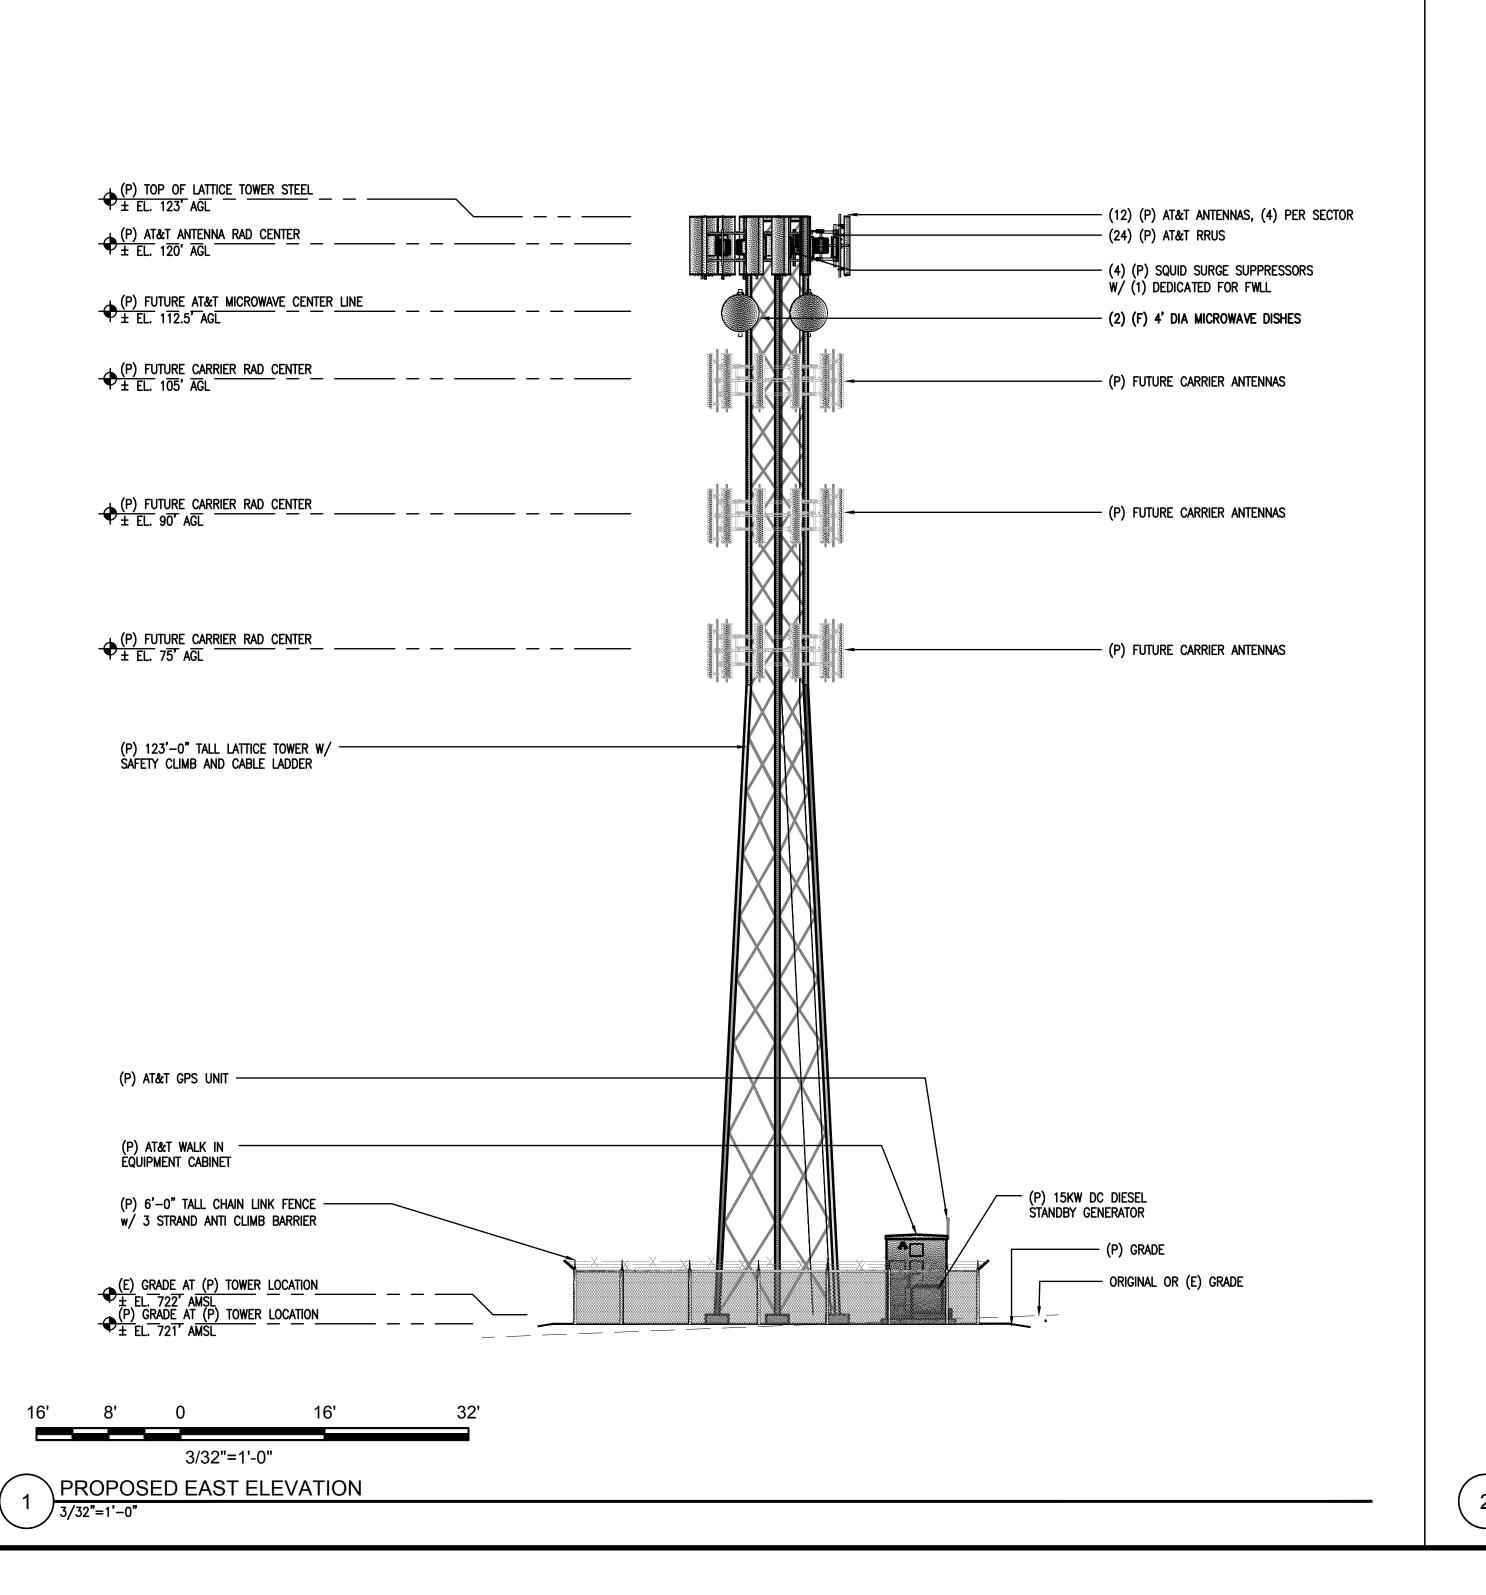
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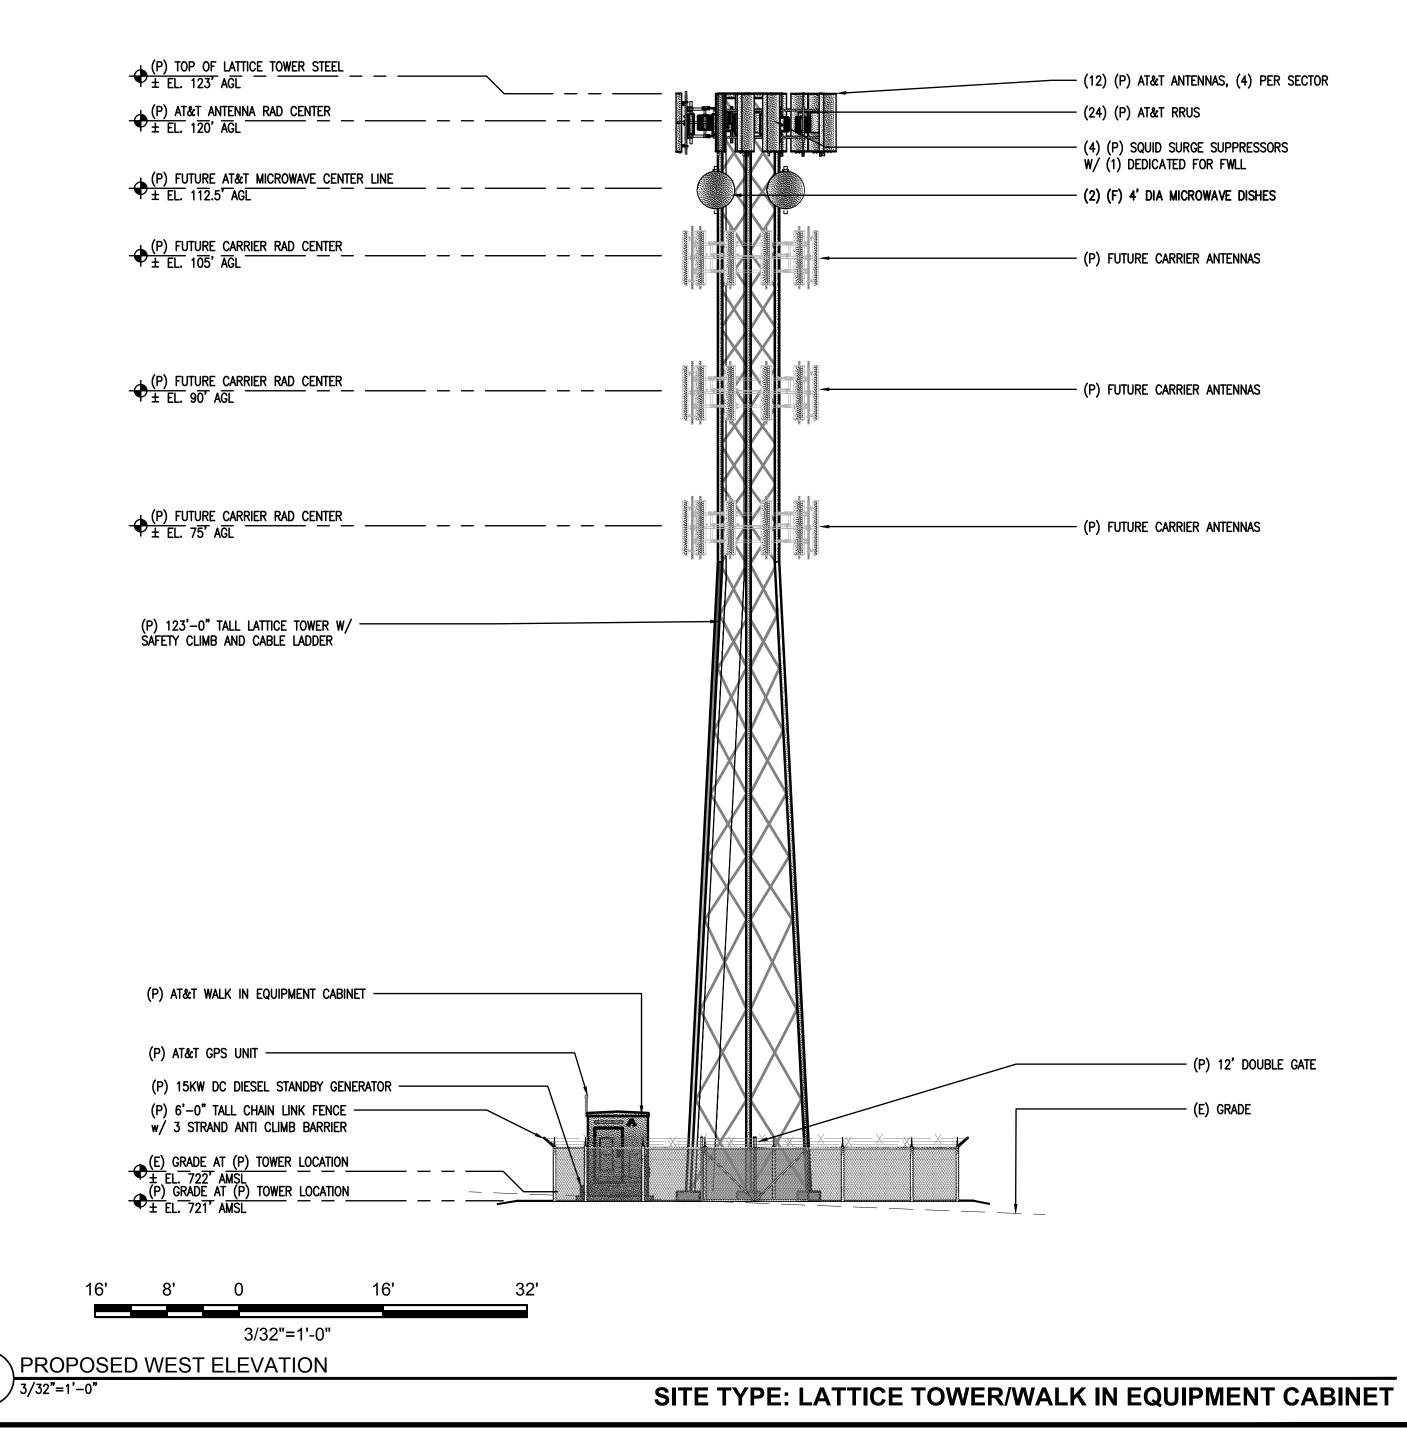
Engineer:

## **ADAPTIVE RE-USE ENGINEERING**

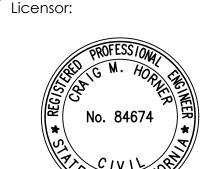Craig Horner, PE 84674 214-407-3184 3112 LEATHA WAY SACRAMENTO, CA 95821 craigmhorner@yahoo.com

SHEET TITLE: PROPOSED LATTICE TOWER NORTH - SOUTH ELEVATION





Issued Fo

GUALALA

GUALALA, CA 95445

39290 OLD STAGE ROAD

PREPARED FOR




2600 Camino Ramon, 4W850 N San Ramon, California 94583



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REV	DATE	DESCRIPTION

Licensor:

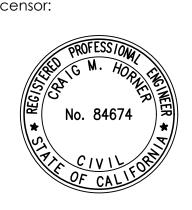

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Engine


## ADAPTIVE RE-USE ENGINEERING

Craig Horner, PE 84674 214-407-3184 3112 LEATHA WAY SACRAMENTO, CA 95821 craigmhorner@yahoo.com

SHEET TITLE:
PROPOSED LATTICE TOWER
WEST - EAST ELEVATION

SHEET NUMBER:

**A-4.2** 

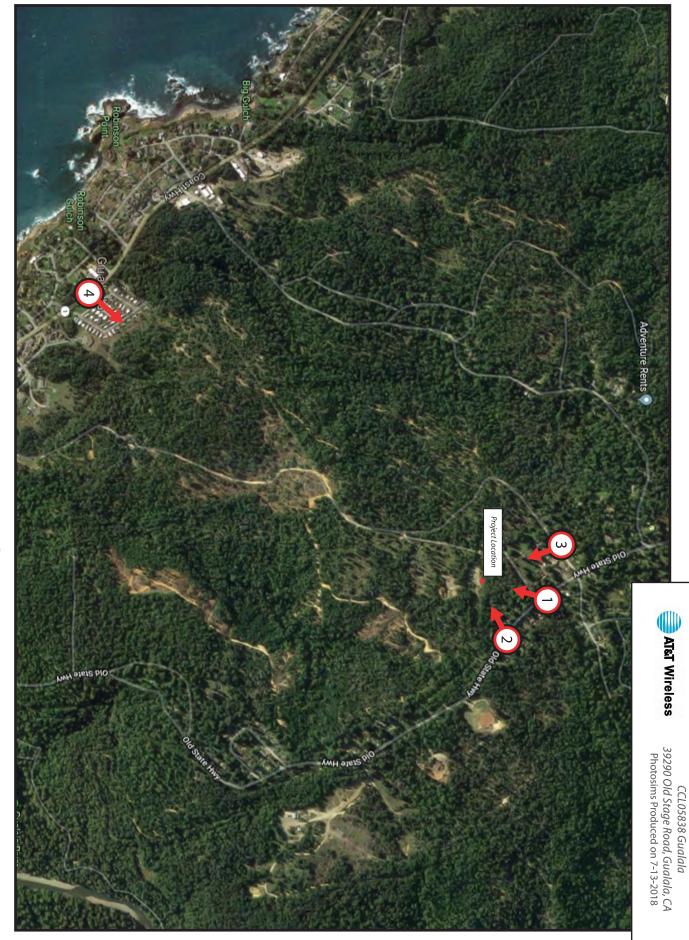










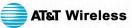

CCL05838 Gualala 39290 Old Stage Road, Gualala, CA Photosims Produced on 7-13-2018





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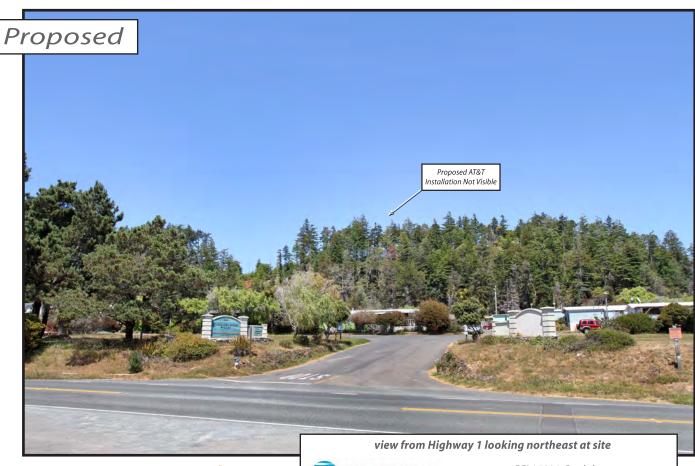


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